21-UNIT N	IULTIFAMILY	2-UNIT MIX SUM	VIARI			
	RINGTON AVE		UNIT SUMMARY			
	ELES, CA 90064	UNIT SECOND FLOOR UNIT #202	UNIT TYPE HAB ROOMS AREA			
1-EXISTING Z	ONING AND SITE INFORMATION	UNIT #202 UNIT #201 UNIT #205 (MANAGER UNIT UNIT #204	2 BDR 3 824.7 SF			
DNING INFORMATION		THIRD FLOOR UNIT #302	2 BDR 3 923.3 SF			
 PROJECT ADDRESS OWNER 	2662 BARRINGTON AVE, LOS ANGELES, CA 90064 2662 AND 2668 S. BARRINGTON AVE. LLC ADRESS: 865 VIA DE LA PAZ #308 PACIFIC PALISADES, CA 90272	UNIT #301 UNIT #305 UNIT #304 UNIT #303	2 BDR 3 824.7 SF 2 BDR 3 854.3 SF 2 BDR 3 949.9 SF 2 BDR (B) 4 1,229.0 SF			
3. APN#	LOT 5 = 4258007027 LOT 6 = 4258-007-028		4,781.2 SF			
4. TRACT	TR 7449	FOURTH FLOOR	2 BDR 3 923.3 SF			
 MAP REFERENCE BLOCK 	M B 127-49 NONE	UNIT #401 UNIT #406 UNIT #405	2 BDR 3 824.7 SF 2 BDR (B) 4 1,146.8 SF 2 BDR 3 854.3 SF			
7. LOT	LOT 5 AND LOT 6	UNIT #403 UNIT #404 UNIT #403	2 BDR 3 034.3 Si 2 BDR 3 949.9 SF 2 BDR (B) 4 1,229.0 SF			
8. GENERAL LAND USE	MEDIUM RESIDENTIAL		5,927.9 SF			
 9. EXISTING UNITS 10. COMMUNITY PLAN AREA 	TOTAL = 2 (LOT 5 = 1 LOT 6 = 1)	FIFTH FLOOR UNIT #502	2 BDR 3 923.3 SF			
11. SPECIFIC PLAN	PALMS - MAR VISTA - DEL REY WEST LOS ANGELES TRANSPORTATION IMPROVEMENT AND MITIGATION	UNIT #501 UNIT #506	2 BDR 3 824.7 SF 2 BDR (B) 4 1,146.8 SF			
12. TOC DESIGNATION	NOT ELIGIBLE	UNIT #505 UNIT #504	2 BDR 3 854.3 SF 2 BDR 3 949.9 SF			
13. LOT AREA PER ZIMAS	TOTAL = 11,998.8 SF (LOT 5 = 5,499.6 SF + LOT 6 = 5,499.2 SF + HALF OF ALLEY = 1	,000 SF) UNIT #503	2 BDR (B) 4 1,229.0 SF 5,927.9 SF 20,189.3 SF			
14. ZONE 15. BASE DENSITY		TOTAL	20, 109.3 Sr			
16. AFFORDABLE UNITS	15 UNITS (ROUNDED UP FROM [11,998.5 SF / 800 SF/DU] PER ZONE R3) 15 UNITS X 15% VLI UNITS = 2.25 (ROUNDED UP) <u>3 VERY LOW INCOME UNITS</u>					
17. BASE F.A.R.	3:1	UNIT BREAK DOWN - DU				
18. HEIGHT LIMIT PER ZONING	45'-0"	UNIT TYPE UNIT COUNT				
19. REQUIRED YARDS FRONT YARD	15' 0"	2 BDR 16 2 BDR (B) 5				
REAR YARD	15'-0" 15'-0" PER LAMC 12.22.C.10	TOTAL 21				
SIDE YARD	8'-0"					
20. BUILDABLE AREA	8,109.9 SF					
21. MAX BUILDABLE AREA	24,329.7 SF = 8,109.9 X 3.0					
2-PROPOSED	PROJECT ZONING INFORMATIO	Ν				
21. SB1818 INCENTIVES (ORDINAL	NCE 179681 AMENDING 12.22 LAMC					
22. 35% DENSITY BONUS PER		UP)				
A. PROPOSED ZONING INCENTIVE 23. 10' - 6" HEIGHT INCREASE		3-OPEN SPACE				
24. 18% FAR INCREASE PER						
24.1 MAX BUILDABLE ARE		1) REQUIRED OPEN SPACE				
25. 20% S.Y. SETBACK REDUC	TION PER 12.22 A 25 (F) (1) 6' - 5" (8'- 0" X 0.8)	2-BEDROOM UNITS	16 UNITS			
26. OFF MENU INCENTIVE FOR OF BULDING LOCATED WITHI	R HEIGHT INCREASE FOR A PORTION N THE 50' -0" OF R-1 LOT (LAMC 12.22	2- BEDROOM WITH BONUS ROOM 125 SE PER 3 HABITABLE ROOMS	5 UNITS			
26. OFF MENU INCENTIVE FOR		125 SF PER 3 HABITABLE ROOMS 175 SF PER 4 HABITABLE ROOMS	5 UNITS 16 X 125 SF = 2,000 SF 5 X 175 SF = 875 SF			
26. OFF MENU INCENTIVE FOR OF BULDING LOCATED WITHI		125 SF PER 3 HABITABLE ROOMS	5 UNITS 16 X 125 SF = 2,000 SF			
26. OFF MENU INCENTIVE FOR OF BULDING LOCATED WITHI	N THE 50' -0" OF R-1 LOT (LAMC 12.22	125 SF PER 3 HABITABLE ROOMS 175 SF PER 4 HABITABLE ROOMS REQUIRED OPEN SPACE: 2) PROVIDED OPEN SPACE	5 UNITS 16 X 125 SF = 2,000 SF 5 X 175 SF = 875 SF 2,875 SF			
26. OFF MENU INCENTIVE FOF OF BULDING LOCATED WITHI A.25 (F)(5)(II)	N THE 50' -0" OF R-1 LOT (LAMC 12.22 Total height allowed: 45 feet	125 SF PER 3 HABITABLE ROOMS 175 SF PER 4 HABITABLE ROOMS REQUIRED OPEN SPACE: 2) PROVIDED OPEN SPACE REC ROOM	5 UNITS 16 X 125 SF = 2,000 SF 5 X 175 SF = 875 SF 2,875 SF 600 SF (<25% OF 2,875 SF)			
26. OFF MENU INCENTIVE FOF OF BULDING LOCATED WITHI A.25 (F)(5)(II)	N THE 50' -0" OF R-1 LOT (LAMC 12.22	125 SF PER 3 HABITABLE ROOMS 175 SF PER 4 HABITABLE ROOMS REQUIRED OPEN SPACE: 2) PROVIDED OPEN SPACE REC ROOM ROOF DECK	5 UNITS 16 X 125 SF = 2,000 SF 5 X 175 SF = 875 SF 2,875 SF 600 SF (<25% OF 2,875 SF) 2,324 SF			
26. OFF MENU INCENTIVE FOP OF BULDING LOCATED WITHIN A.25 (F)(5)(II)	Total height allowed: 45 feet PROJECT BUILDING INFORMATI	125 SF PER 3 HABITABLE ROOMS 175 SF PER 4 HABITABLE ROOMS REQUIRED OPEN SPACE: 2) PROVIDED OPEN SPACE REC ROOM	5 UNITS 16 X 125 SF = 2,000 SF 5 X 175 SF = 875 SF 2,875 SF 600 SF (<25% OF 2,875 SF)			
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26. OFF MENU INCENTIVE FOR OF BULDING LOCATED WITHIN A.25 (F)(5)(II) 3-PROPOSED DITIONAL INFORMATION 27. BUILDING OCCUPANCY 28. CONSTRUCTION TYPE	Total height allowed: 45 feet PROJECT BUILDING INFORMATI R2 (MULTI-FAMILY) / OVER S2 PARKING 5-STORIES TOTAL. 4 STORIES TYPE-VA RESIDENTIAL OVER 1 STORY TYPE I-A GARAGE AT GRADE OVER TYPE I-A SUBTERRANEAN GARAGE	125 SF PER 3 HABITABLE ROOMS 175 SF PER 4 HABITABLE ROOMS REQUIRED OPEN SPACE: 2) PROVIDED OPEN SPACE REC ROOM ROOF DECK	5 UNITS 16 X 125 SF = 2,000 SF 5 X 175 SF = 875 SF 2,875 SF 600 SF (<25% OF 2,875 SF) 2,324 SF			
26. OFF MENU INCENTIVE FOR OF BULDING LOCATED WITHIN A.25 (F)(5)(II) 3-PROPOSED DITIONAL INFORMATION 27. BUILDING OCCUPANCY 28. CONSTRUCTION TYPE 29. APPLICABLE CODES	THE 50'-0" OF R-1 LOT (LAMC 12.22 Total height allowed: 45 feet PROJECT BUILDING INFORMATI R2 (MULTI-FAMILY) / OVER S2 PARKING 5-STORIES TOTAL. 4 STORIES TYPE-VA RESIDENTIAL OVER 1 STORY TYPE I-A GARAGE AT GRADE OVER TYPE I-A SUBTERRANEAN GARAGE 2019 CBC W/ 2020 CITY OF LA AMENDMENTS	125 SF PER 3 HABITABLE ROOMS 175 SF PER 4 HABITABLE ROOMS REQUIRED OPEN SPACE: 2) PROVIDED OPEN SPACE REC ROOM ROOF DECK	5 UNITS 16 X 125 SF = 2,000 SF 5 X 175 SF = 875 SF 2,875 SF 600 SF (<25% OF 2,875 SF) 2,324 SF			
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26. OFF MENU INCENTIVE FOR OF BULDING LOCATED WITHIN A.25 (F)(5)(II) 3-PROPOSED DITIONAL INFORMATION 27. BUILDING OCCUPANCY 28. CONSTRUCTION TYPE 29. APPLICABLE CODES	THE 50' -0" OF R-1 LOT (LAMC 12.22 Total height allowed: 45 feet PROJECT BUILDING INFORMATI R2 (MULTI-FAMILY) / OVER S2 PARKING 5-STORIES TOTAL. 4 STORIES TYPE-VA RESIDENTIAL OVER 1 STORY TYPE I-A GARAGE AT GRADE OVER TYPE I-A SUBTERRANEAN GARAGE 2019 CBC W/ 2020 CITY OF LA AMENDMENTS FULLY SPRINKLERED PER NFPA-13 THIS BUILDING AND GARAGE MUST BE EQUIPPED WITH AN AUTOMATIC FIRE	125 SF PER 3 HABITABLE ROOMS 175 SF PER 4 HABITABLE ROOMS REQUIRED OPEN SPACE: 2) PROVIDED OPEN SPACE REC ROOM ROOF DECK	5 UNITS 16 X 125 SF = 2,000 SF 5 X 175 SF = 875 SF 2,875 SF 600 SF (<25% OF 2,875 SF) 2,324 SF 2,924 SF (>2,625 SF) BICYCLE PAR			
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26. OFF MENU INCENTIVE FOR OF BULDING LOCATED WITHIN A.25 (F)(5)(II) 3-PROPOSED DITIONAL INFORMATION 27. BUILDING OCCUPANCY 28. CONSTRUCTION TYPE 29. APPLICABLE CODES 30. FIRE SPRINKLER	THE 50'-0" OF R-1 LOT (LAMC 12.22 Total height allowed: 45 feet PROJECT BUILDING INFORMATI R2 (MULTI-FAMILY) / OVER S2 PARKING 5-STORIES TOTAL. 4 STORIES TYPE-VA RESIDENTIAL OVER 1 STORY TYPE I-A GARAGE AT GRADE OVER TYPE I-A SUBTERRANEAN GARAGE 2019 CBC W/ 2020 CITY OF LA AMENDMENTS FULLY SPRINKLERED PER NFPA-13 THIS BUILDING AND GARAGE MUST BE EQUIPPED WITH AN AUTOMATIC FIRE EXTINGUISHING SYSTEM, COMPLYING WITH NFPA-13. THE SPRINKLER SYSTEM SHALL BE APPROVED BY PLUMBING DIV PRIOR TO INSTALLATION	125 SF PER 3 HABITABLE ROOMS 175 SF PER 4 HABITABLE ROOMS REQUIRED OPEN SPACE: 2) PROVIDED OPEN SPACE REC ROOM ROOF DECK TOTAL OPEN SPACE PROVIDED: VEHICLE PARKING - PER PARKING OPTION 2 BDR = 21 UNITS x 2 STALLS = 10 % REDUCTION PER LAMC 12.22 A.25 TOTAL REQ. PARKING	5 UNITS 16 X 125 SF = 2,000 SF 5 X 175 SF = 875 SF 2,875 SF 600 SF (<25% OF 2,875 SF) 2,324 SF 2,924 SF (>2,625 SF) BICCYCLE PARE 1/UNDER SB1818 2 STALLS 42 PARKING MIN. 4 (42 X 0.1 = 4.2 ROUNDED DOWN			
26. OFF MENU INCENTIVE FOR OF BULDING LOCATED WITHIN A.25 (F)(5)(II) 3-PROPOSED DITIONAL INFORMATION 27. BUILDING OCCUPANCY 28. CONSTRUCTION TYPE 29. APPLICABLE CODES 30. FIRE SPRINKLER	THE 50'-0" OF R-1 LOT (LAMC 12.22 Total height allowed: 45 feet PROJECT BUILDING INFORMATI R2 (MULTI-FAMILY) / OVER S2 PARKING 5-STORIES TOTAL. 4 STORIES TYPE-VA RESIDENTIAL OVER 1 STORY TYPE I-A GARAGE AT GRADE OVER TYPE I-A SUBTERRANEAN GARAGE 2019 CBC W/ 2020 CITY OF LA AMENDMENTS FULLY SPRINKLERED PER NFPA-13 THIS BUILDING AND GARAGE MUST BE EQUIPPED WITH AN AUTOMATIC FIRE EXTINGUISHING SYSTEM, COMPLYING WITH NFPA-13. THE SPRINKLER SYSTEM SHALL BE APPROVED BY PLUMBING DIV PRIOR TO INSTALLATION	125 SF PER 3 HABITABLE ROOMS 175 SF PER 4 HABITABLE ROOMS REQUIRED OPEN SPACE: (2) PROVIDED OPEN SPACE REC ROOM ROOF DECK TOTAL OPEN SPACE PROVIDED: VEHICLE PARKING - PER PARKING OPTION 2 BDR = 21 UNITS x 2 STALLS = 10 % REDUCTION PER LAMC 12.22 A.25 TOTAL REQ. PARKING PROPOSED PARKING PROPOSED PARKING PRIMARY STANDARD = PRIMARY STANDARD =	5 UNITS 16 X 125 SF = 2,000 SF 5 X 175 SF = 875 SF 2,875 SF 600 SF (<25% OF 2,875 SF) 2,324 SF 2,924 SF (>2,625 SF) BICCYCLE PARK 1/UNDER SB1818 2 STALLS 42 PARKING MIN. 4 (42 X 0.1 = 4.2 ROUNDED DOWN 38 (42 - 4) 21 13			
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5-FLOOR AREA-ZONING CODE

ZONING SF SUMMARY

AREA

1,305.4 SF

6,503.7 SF

6,503.7 SF 6,500.2 SF

6,500.2 SF

27,313.2 SF

	UNIT SUM	MARY		
	UNIT TYPE	HAB ROOMS	AREA	REQ OPEN SPACE
)2	2 BDR	3	923.3 SF	125.0 SF
)1	2 BDR	3	824.7 SF	125.0 SF
05 (MANAGER UNIT)	2 BDR	3	854.3 SF	125.0 SF
)4	2 BDR	3	949.9 SF	125.0 SF
		-	3,552.2 SF	500.0 SF
			-,	
		I	I	
)2	2 BDR	3	923.3 SF	125.0 SF
)1	2 BDR	3	824.7 SF	125.0 SF
)5	2 BDR	3	854.3 SF	125.0 SF
)4	2 BDR	3	949.9 SF	125.0 SF
)3	2 BDR (B)	4	1,229.0 SF	175.0 SF
			4,781.2 SF	675.0 SF
			000.00	105.0.05
)2	2 BDR	3	923.3 SF	125.0 SF
)1	2 BDR	3	824.7 SF	125.0 SF
06	2 BDR (B)	4	1,146.8 SF	175.0 SF
)5	2 BDR	3	854.3 SF	125.0 SF
)4	2 BDR	3	949.9 SF	125.0 SF
)3	2 BDR (B)	4	1,229.0 SF	175.0 SF
			5,927.9 SF	850.0 SF
)2	2 BDR	3	923.3 SF	125.0 SF
)1	2 BDR	3	824.7 SF	125.0 SF
)6	2 BDR (B)	4	1,146.8 SF	175.0 SF
)5	2 BDR (B)	3	854.3 SF	125.0 SF
)4	2 BDR	3	949.9 SF	125.0 SF
/¬		5	0-0.001	120.0 01

175.0 SF

850.0 SF

2,875.0 SF

SEE SHEET T-03 FOR ZONING SQUARE FOOTAGE DIAGRAMS AND AREA SCHEDULES PER FLOOR

FLOOR

1ST FLOOR

2ND FLOOR

3RD FLOOR

4TH FLOOR

5TH FLOOR

TOTAL

D	A	С	Ε


PACE	
BONUS ROOM	16 UNITS 5 UNITS
ABLE ROOMS ABLE ROOMS	16 X 125 SF = 5 X 175 SF =
PACE:	2,875 SF

E AND B	SICYCL	E PARKING
R PARKING OPTION 1	UNDER SB1818	
	2 STALLS	
	42 PARKING MIN	۹.
AMC 12.22 A.25	4 (42 X 0.1 = 4.2 I	ROUNDED DOWN)
	38 (42 - 4)	
	21	
	13 5	
KING =	39	
ARKING		
S: 1 BICYCLE PARKIN	G PER UNIT = 2	21 X 1 = 21 (LAMC 12.21 A.16. (A)(1)(I))
TERM BICYCLE PAR	KING	= 21
G TERM BICYCLE PAI		= <u>24</u>
PARKING		
		= 21 / 10 = 2.1 = (ROUNDED DOWN) <u>2 REQUIRED</u>
M BICYCLE PARKING		<u>2 PROVIDED</u>

PROJECT:

21-UNIT MULTI FAMILY BUILDING
2662 BARRINGTON AVE LOS ANGELES, CA 90064

ISSUE	DATE
1	1/18/2023
2	03/31/2023
3	04/27/2023

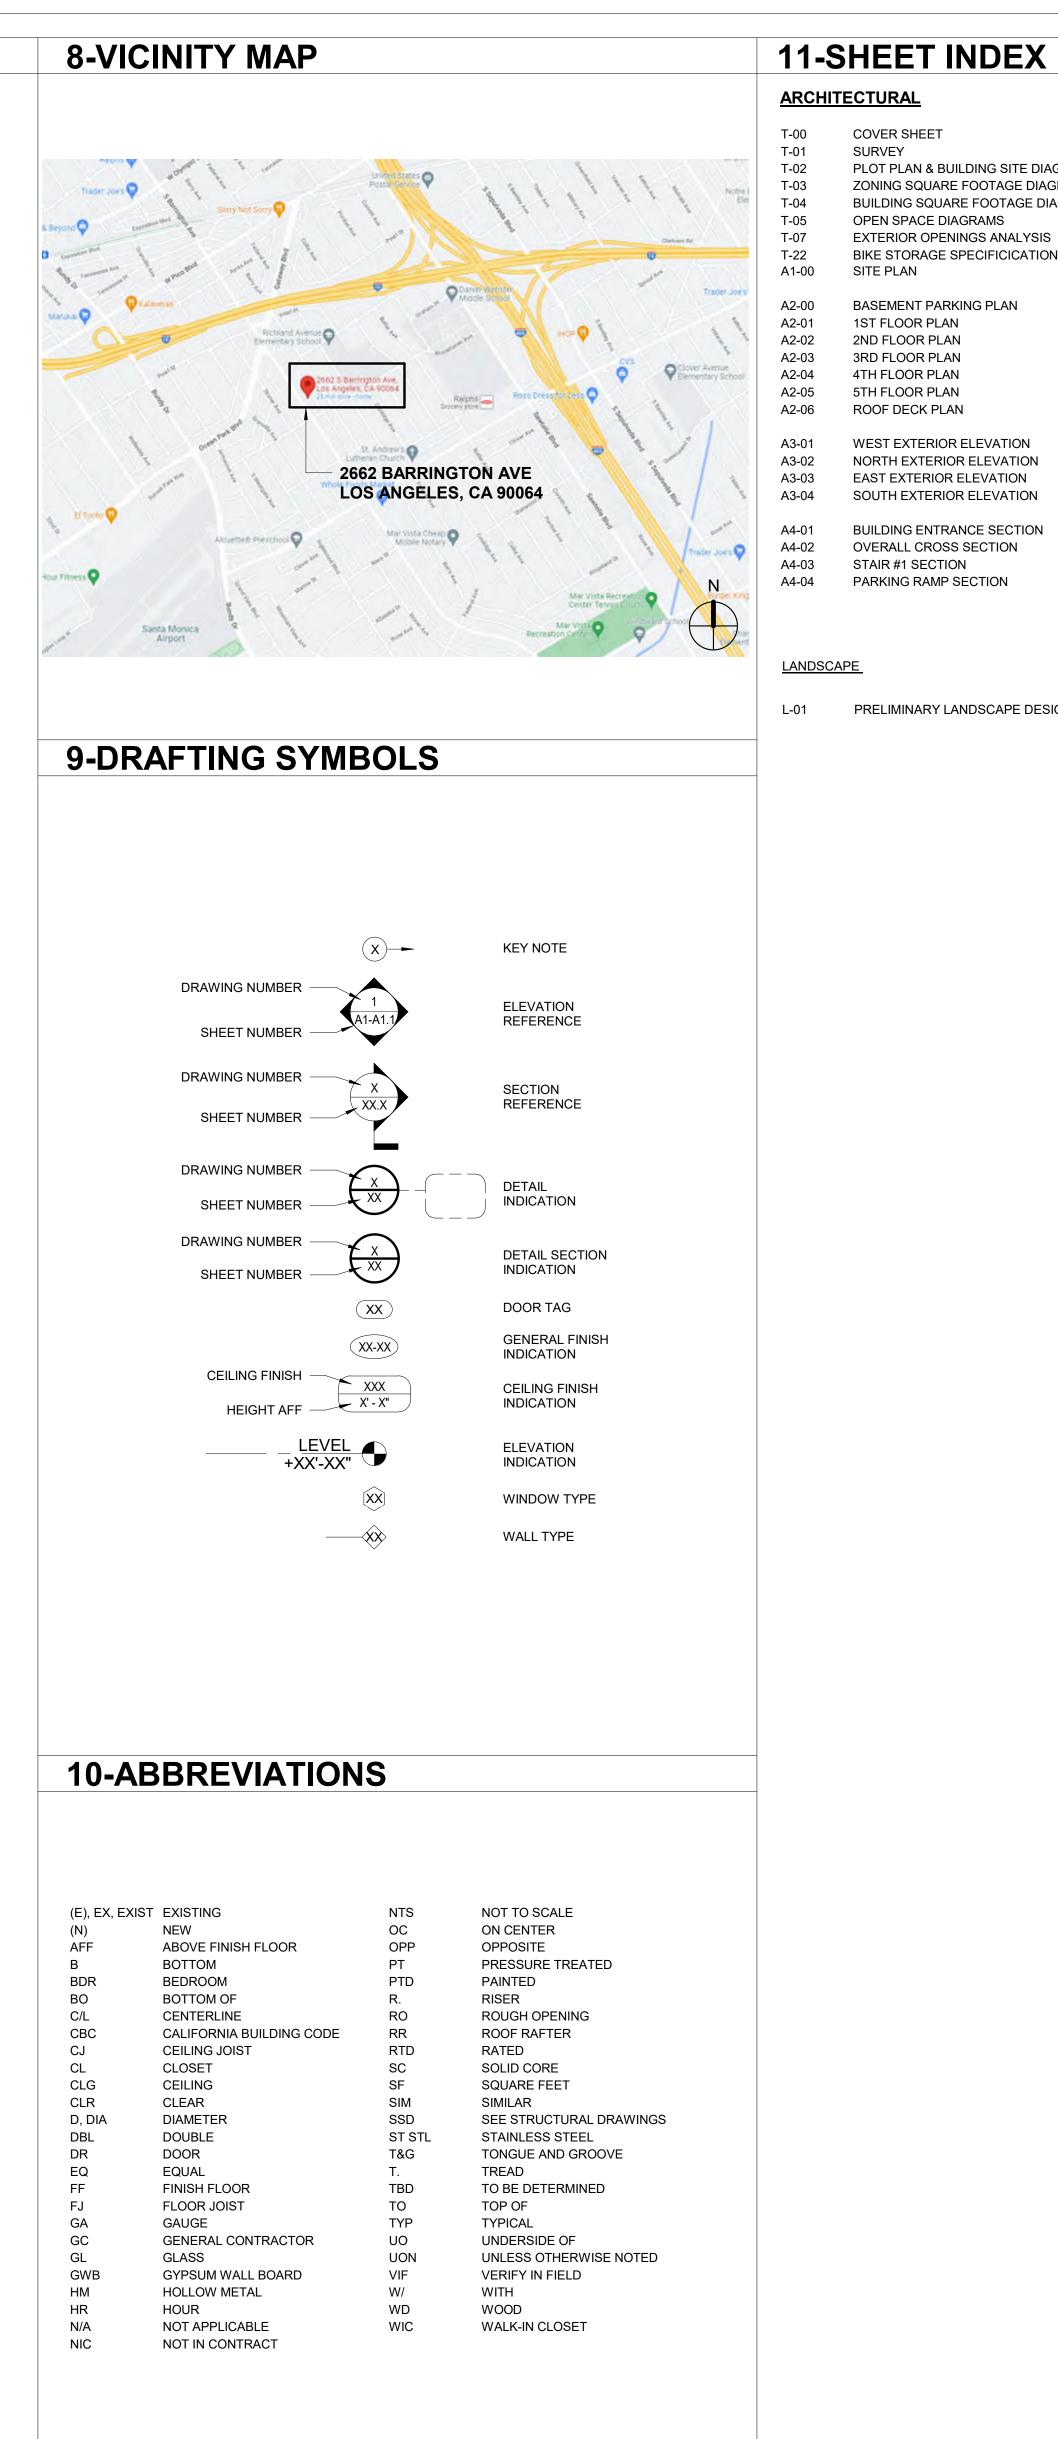

STAMP SED ARCHIN DESCRIPTION ISSUE DATE DESCRIPTION PZA SUBMITTAL#1 PZA CORRECTIONS #1 PZA CORRECTIONS #2 AARON BRUMER No. C-30005 _____ REN. 11-30-2023 Aleron Ber FOFCAL

DRAWING TITLE COVER SHEET


ARCHITECTURAL COVER SHEET T-00 T-01 SURVEY PLOT PLAN & BUILDING SITE DIAGRAMS T-02 T-03 ZONING SQUARE FOOTAGE DIAGRAMS BUILDING SQUARE FOOTAGE DIAGRAMS T-04 T-05 OPEN SPACE DIAGRAMS T-07 EXTERIOR OPENINGS ANALYSIS T-22 BIKE STORAGE SPECIFICICATION A1-00 SITE PLAN BASEMENT PARKING PLAN A2-00 A2-01 1ST FLOOR PLAN 2ND FLOOR PLAN A2-02 A2-03 3RD FLOOR PLAN A2-04 4TH FLOOR PLAN 5TH FLOOR PLAN A2-05 ROOF DECK PLAN A2-06 WEST EXTERIOR ELEVATION A3-01 NORTH EXTERIOR ELEVATION A3-02


A3-03 EAST EXTERIOR ELEVATION SOUTH EXTERIOR ELEVATION A3-04 BUILDING ENTRANCE SECTION A4-01 OVERALL CROSS SECTION A4-02 A4-03 STAIR #1 SECTION

PARKING RAMP SECTION

LANDSCAPE

PRELIMINARY LANDSCAPE DESIGN L-01

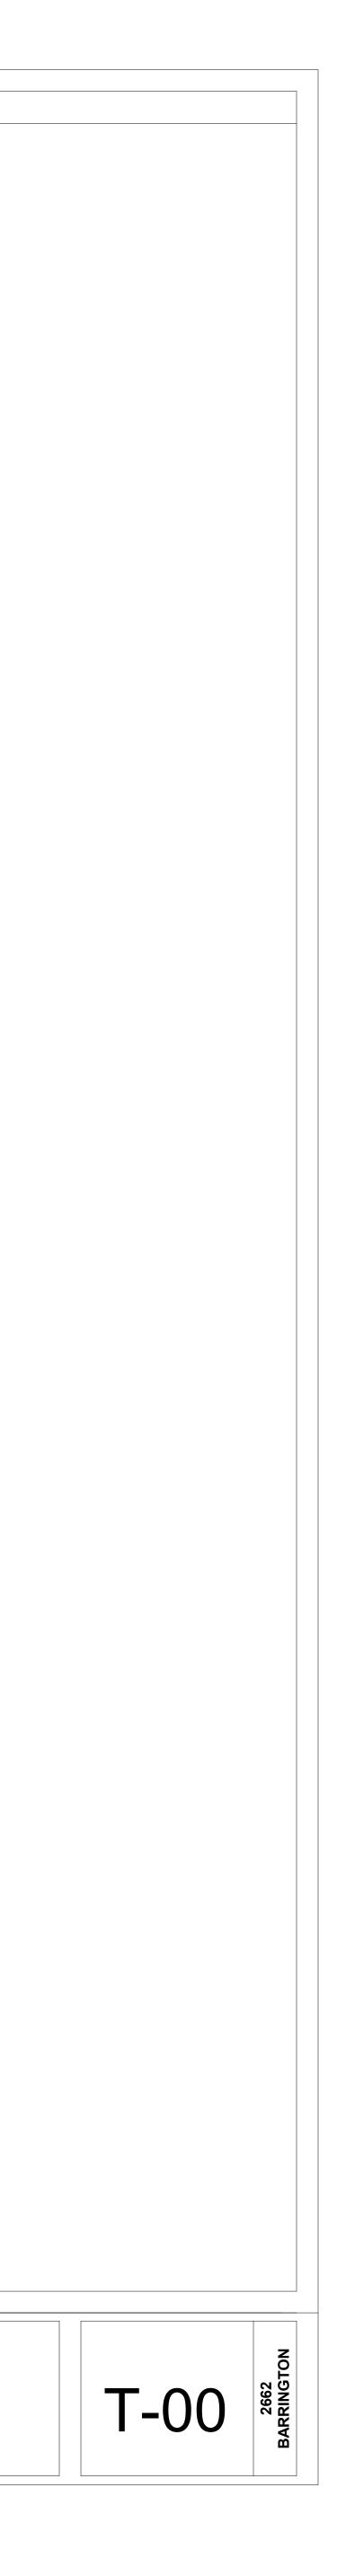

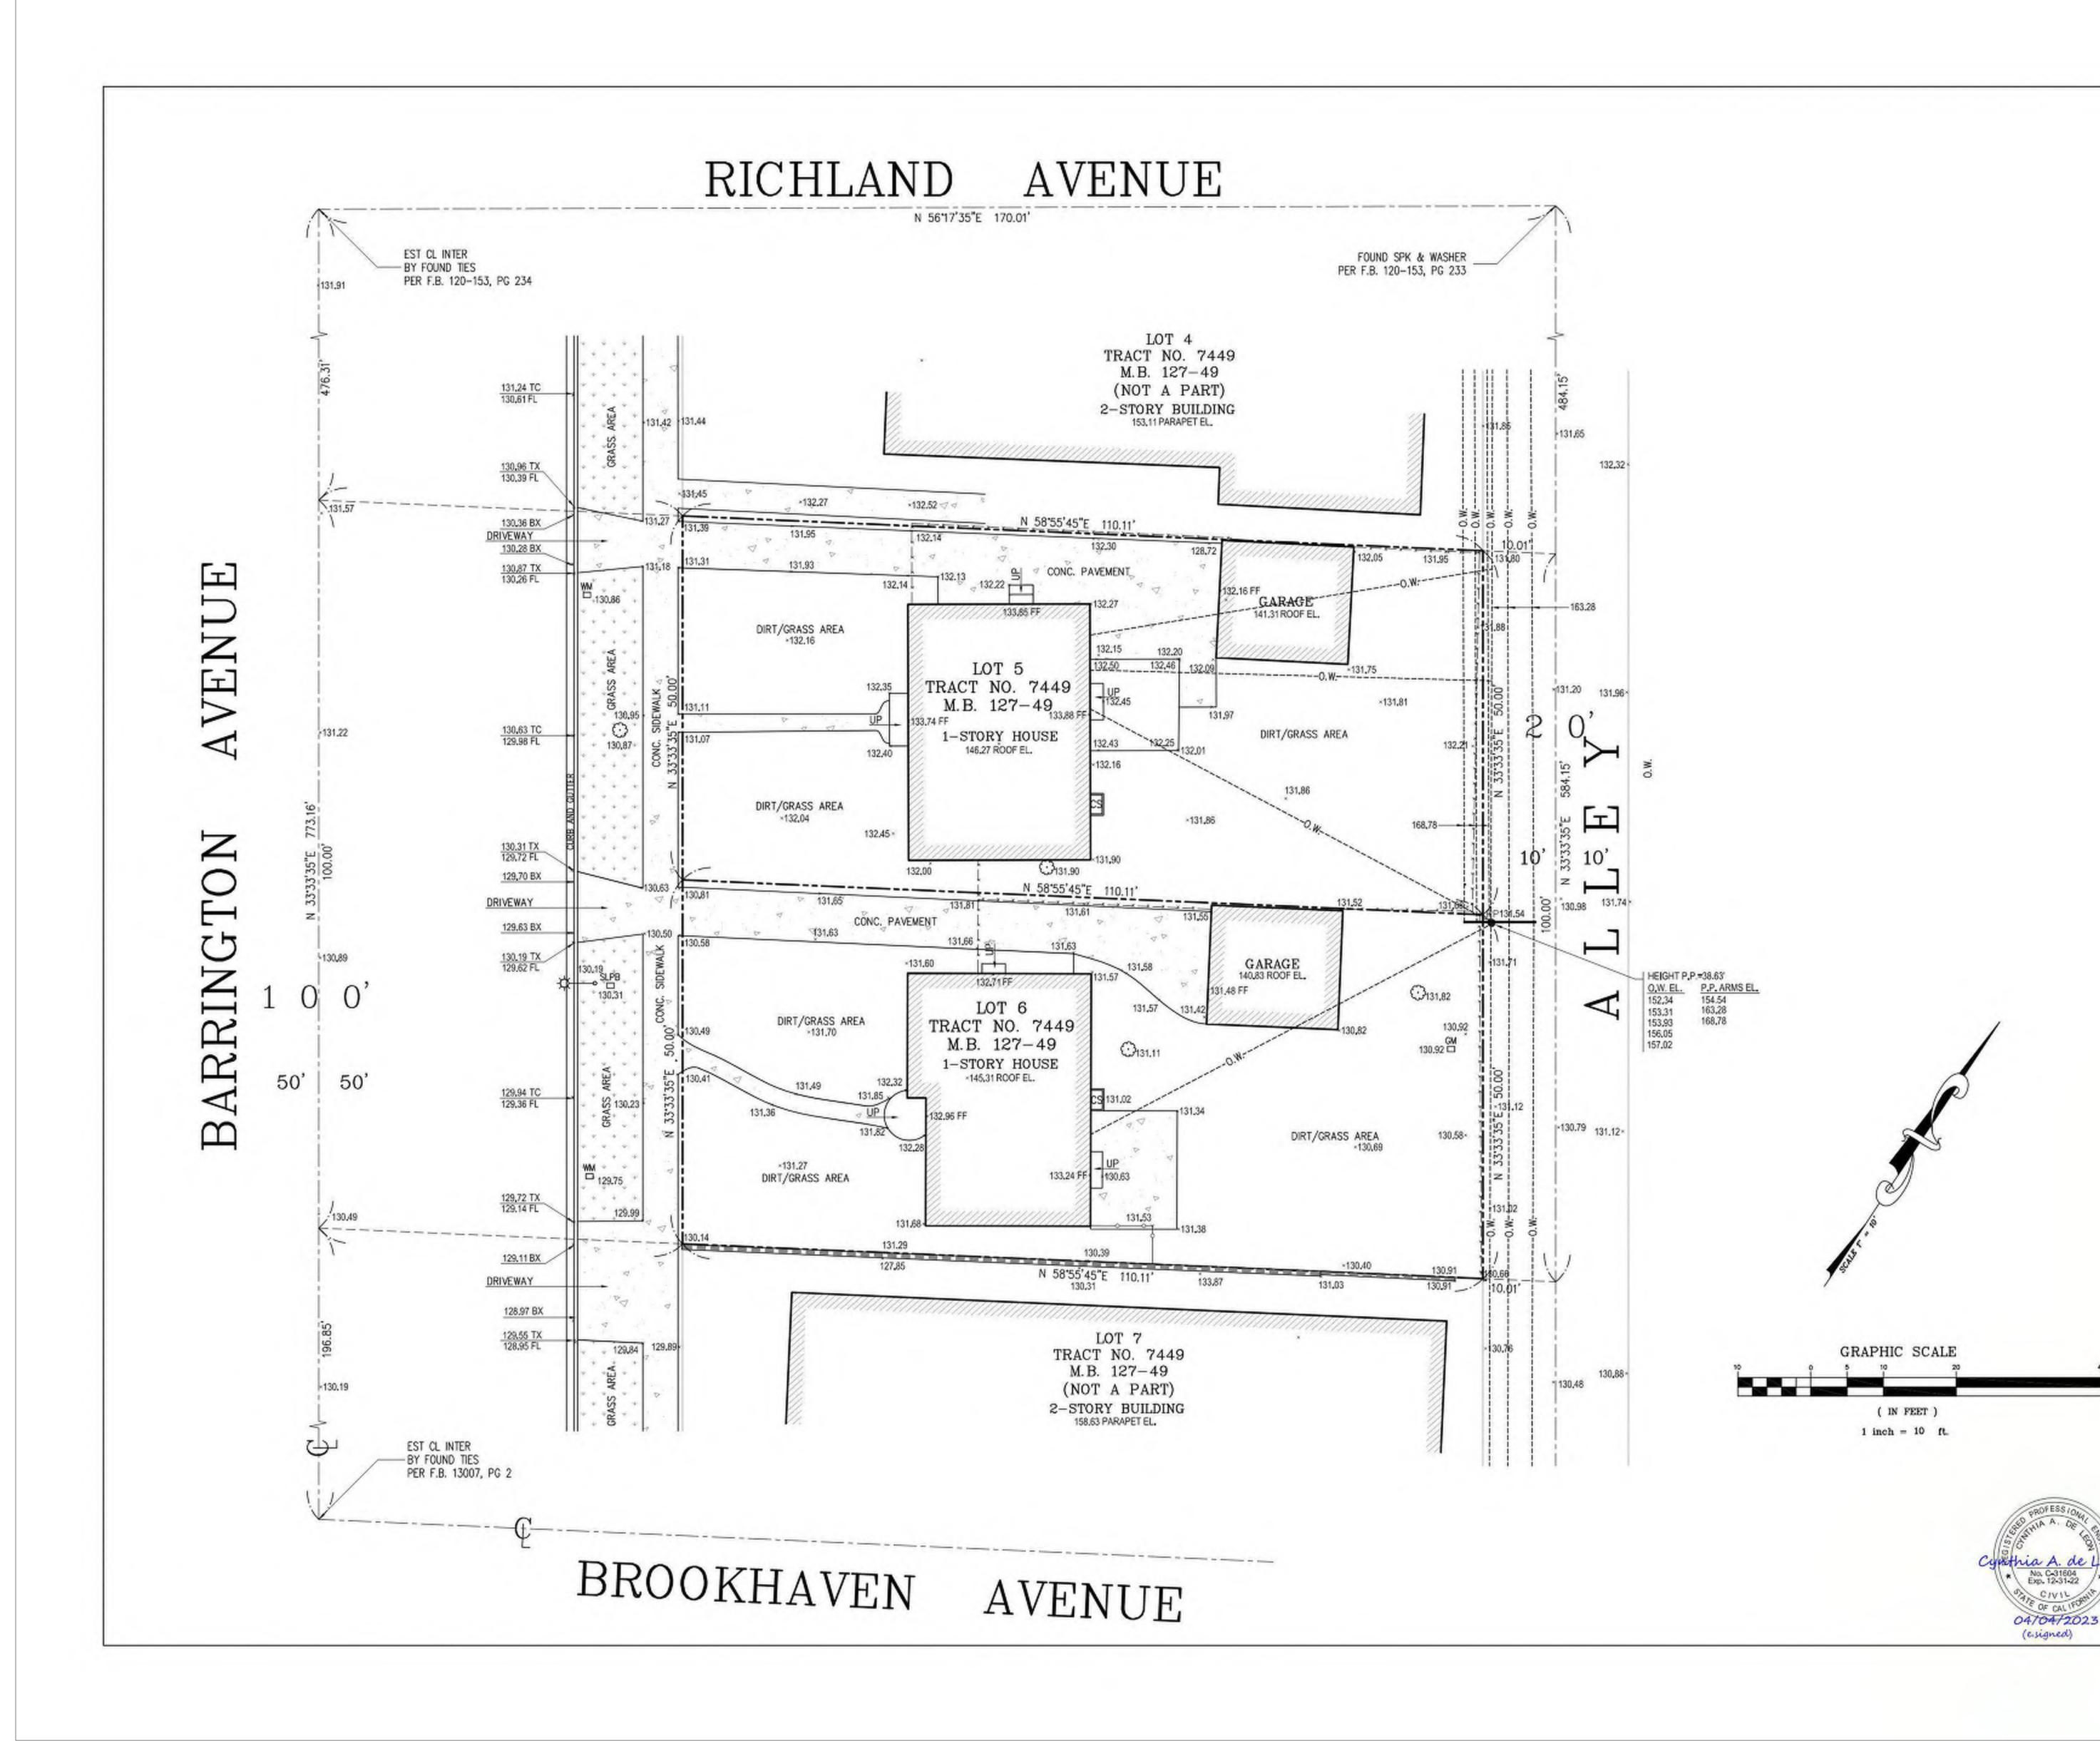

ARCHITECT: Aaron Brumer & Assoc, Architects 10999 Riverside Drive, Suite 300 North Hollywood, CA 91602 (310) 422-9234 Email - aaron@aaronbrumer.com

STRUCTURAL: **Amir Pirbadian, Inc.** 17514 Ventura Blvd., #206 Encino, CA 91436 (818) 990-6425 Èmail - aandgstreng@gmail.com

CIVIL:


Obando and Associates, Inc. 3101 Ocean Park Blvd., Suite #100 PMB 122 Santa Monica, CA 90405 (818) 990-6425 Èmail - aandgstreng@gmail.com


	ISSUE	DATE
PROJECT:	1	1/18/202
FNOJLOI.	2	03/31/20
21-UNIT MULTI FAMILY BUILDING	3	04/17/20
	4	05/08/20
2662 BARRINGTON AVE		
LOS ANGELES, CA 90064		

PN	-	ASSESSOR'S PARCEL NUMBER
LC.	-	ASPHALT CONCRETE
8.C.	-	BEGINNING OF CURVE
M	-	BENCHMARK
C/CL	-	CENTERLINE
S		CRAWL SPACE
ST	-	ESTABLISH
D	-	FOUND
D F	-	FINISH FLOOR ELEV.
s	-	FINISH SURFACE ELEV.
NTER	-	INTERSECTION
& T	-	LEAD & TACK
IB	-	MAP BOOK
G	-	PAGE
		PROPERTY LINE
		PRODUCED (PROLONCED)
WFB	-	PUBLIC WORK'S FIELD BOOK
30F	-	REGISTERED CIVIL ENGINEER
MH	-	SEWER MANHOLE
X	-	TOP OF "X"
XX.	-	
C	-	TOP OF CURB ELEV.
R	-	
		PROPERTY LINE
		CENTERLINE


 CENTERLINE BLOCK WALL

BUILDING LINE

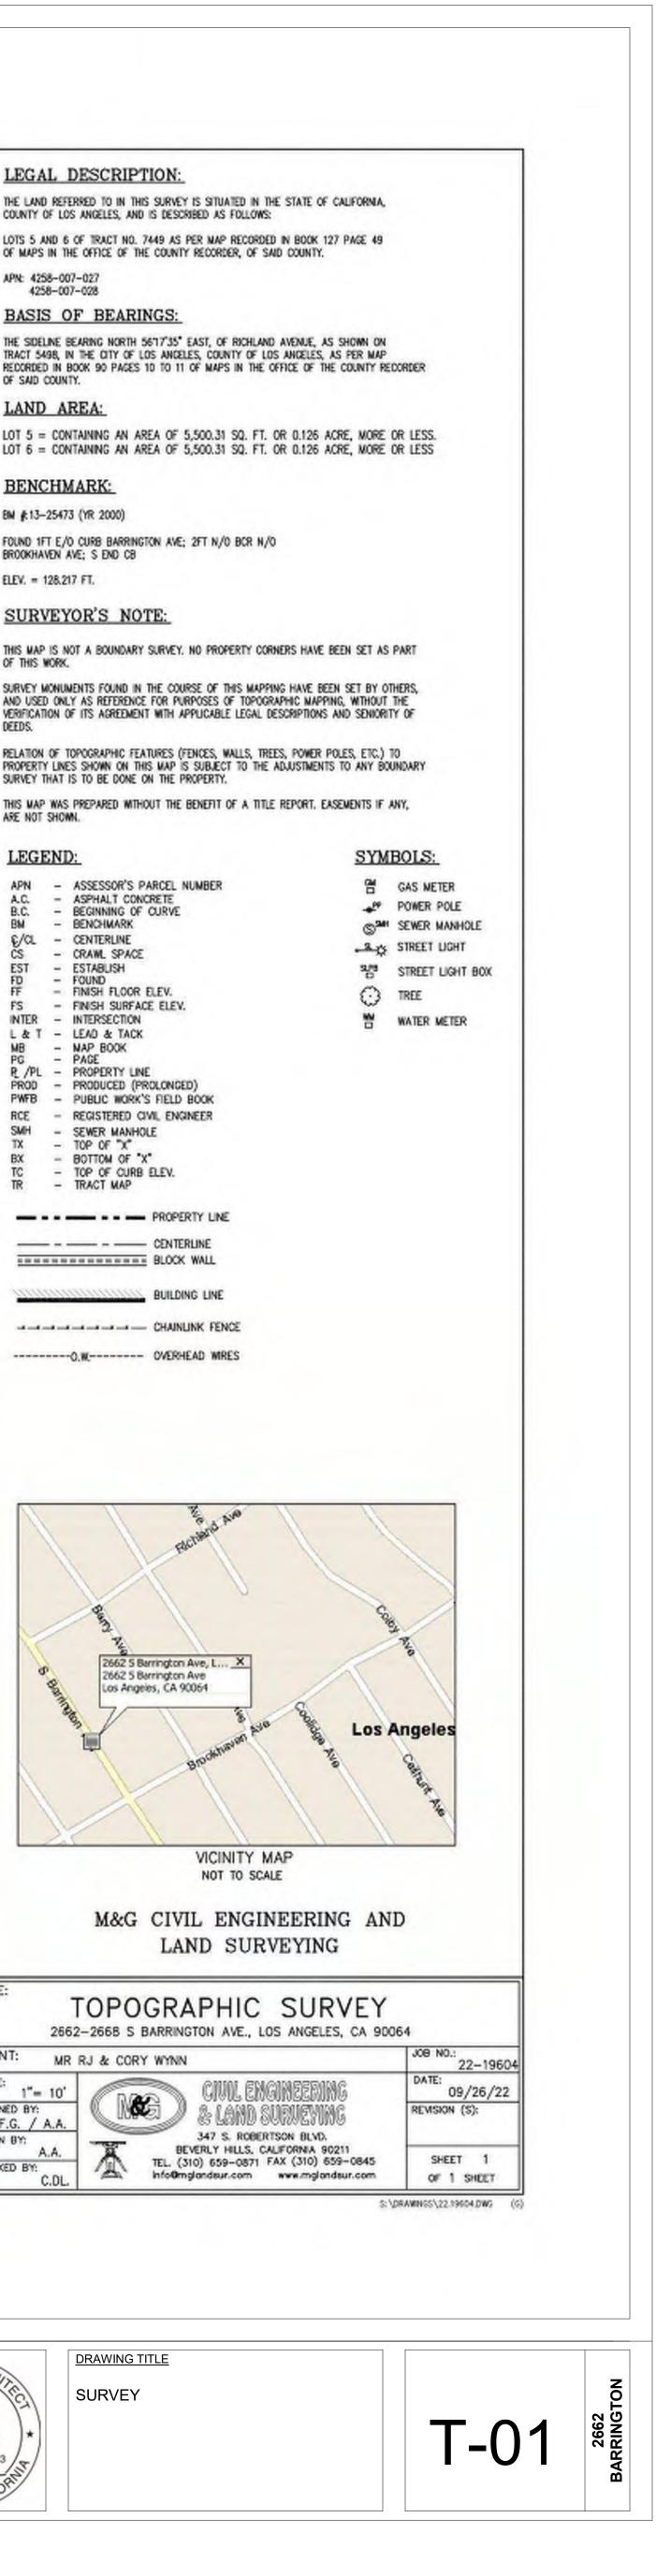

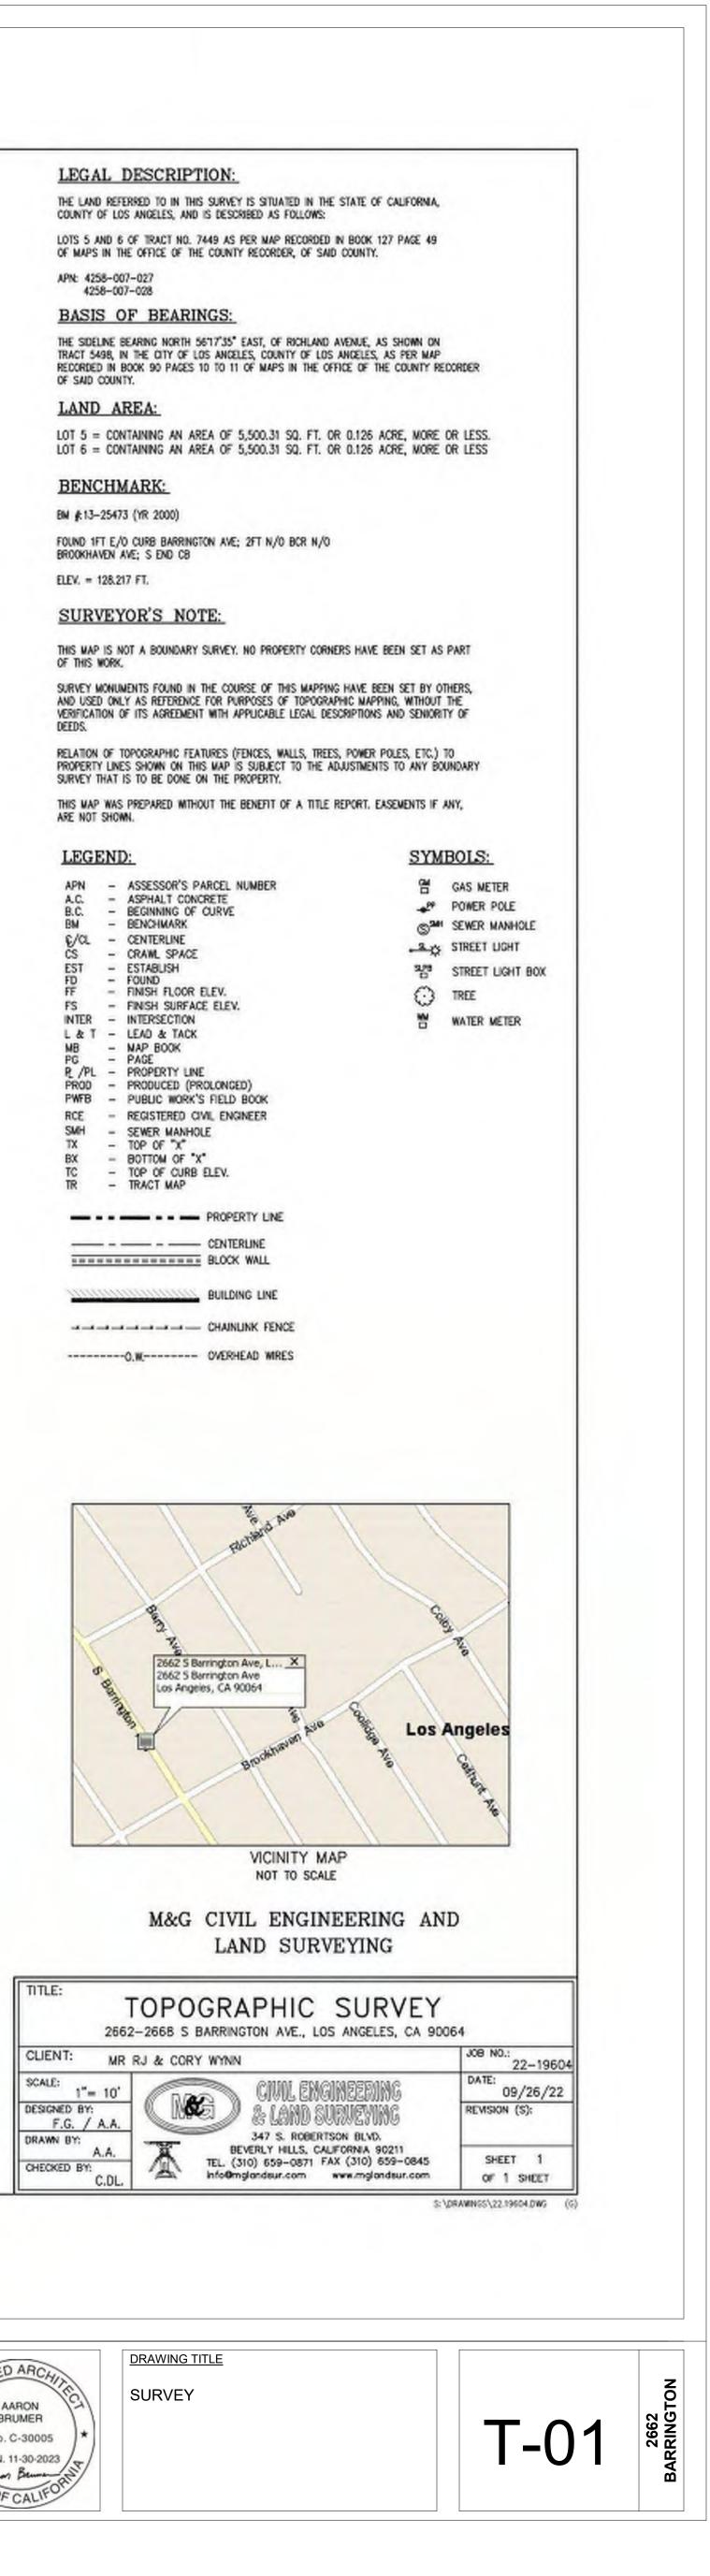

ESCRIPTION	ISSUE DATE	DESCRIPTION	STAMP	DRAWING TITLE
PZA SUBMITTAL#1			NSED ARCHIN	
PZA CORRECTIONS #1			Car Int	SURVEY
PZA CORRECTIONS #2			J AARON JA	SORVET
PZA CORRECTIONS #3			BRUMER	
			* No. C-30005 *	
			BEN. 11-30-2023	
			Aug Berne St	
			E OF OF	
			OFCALI	

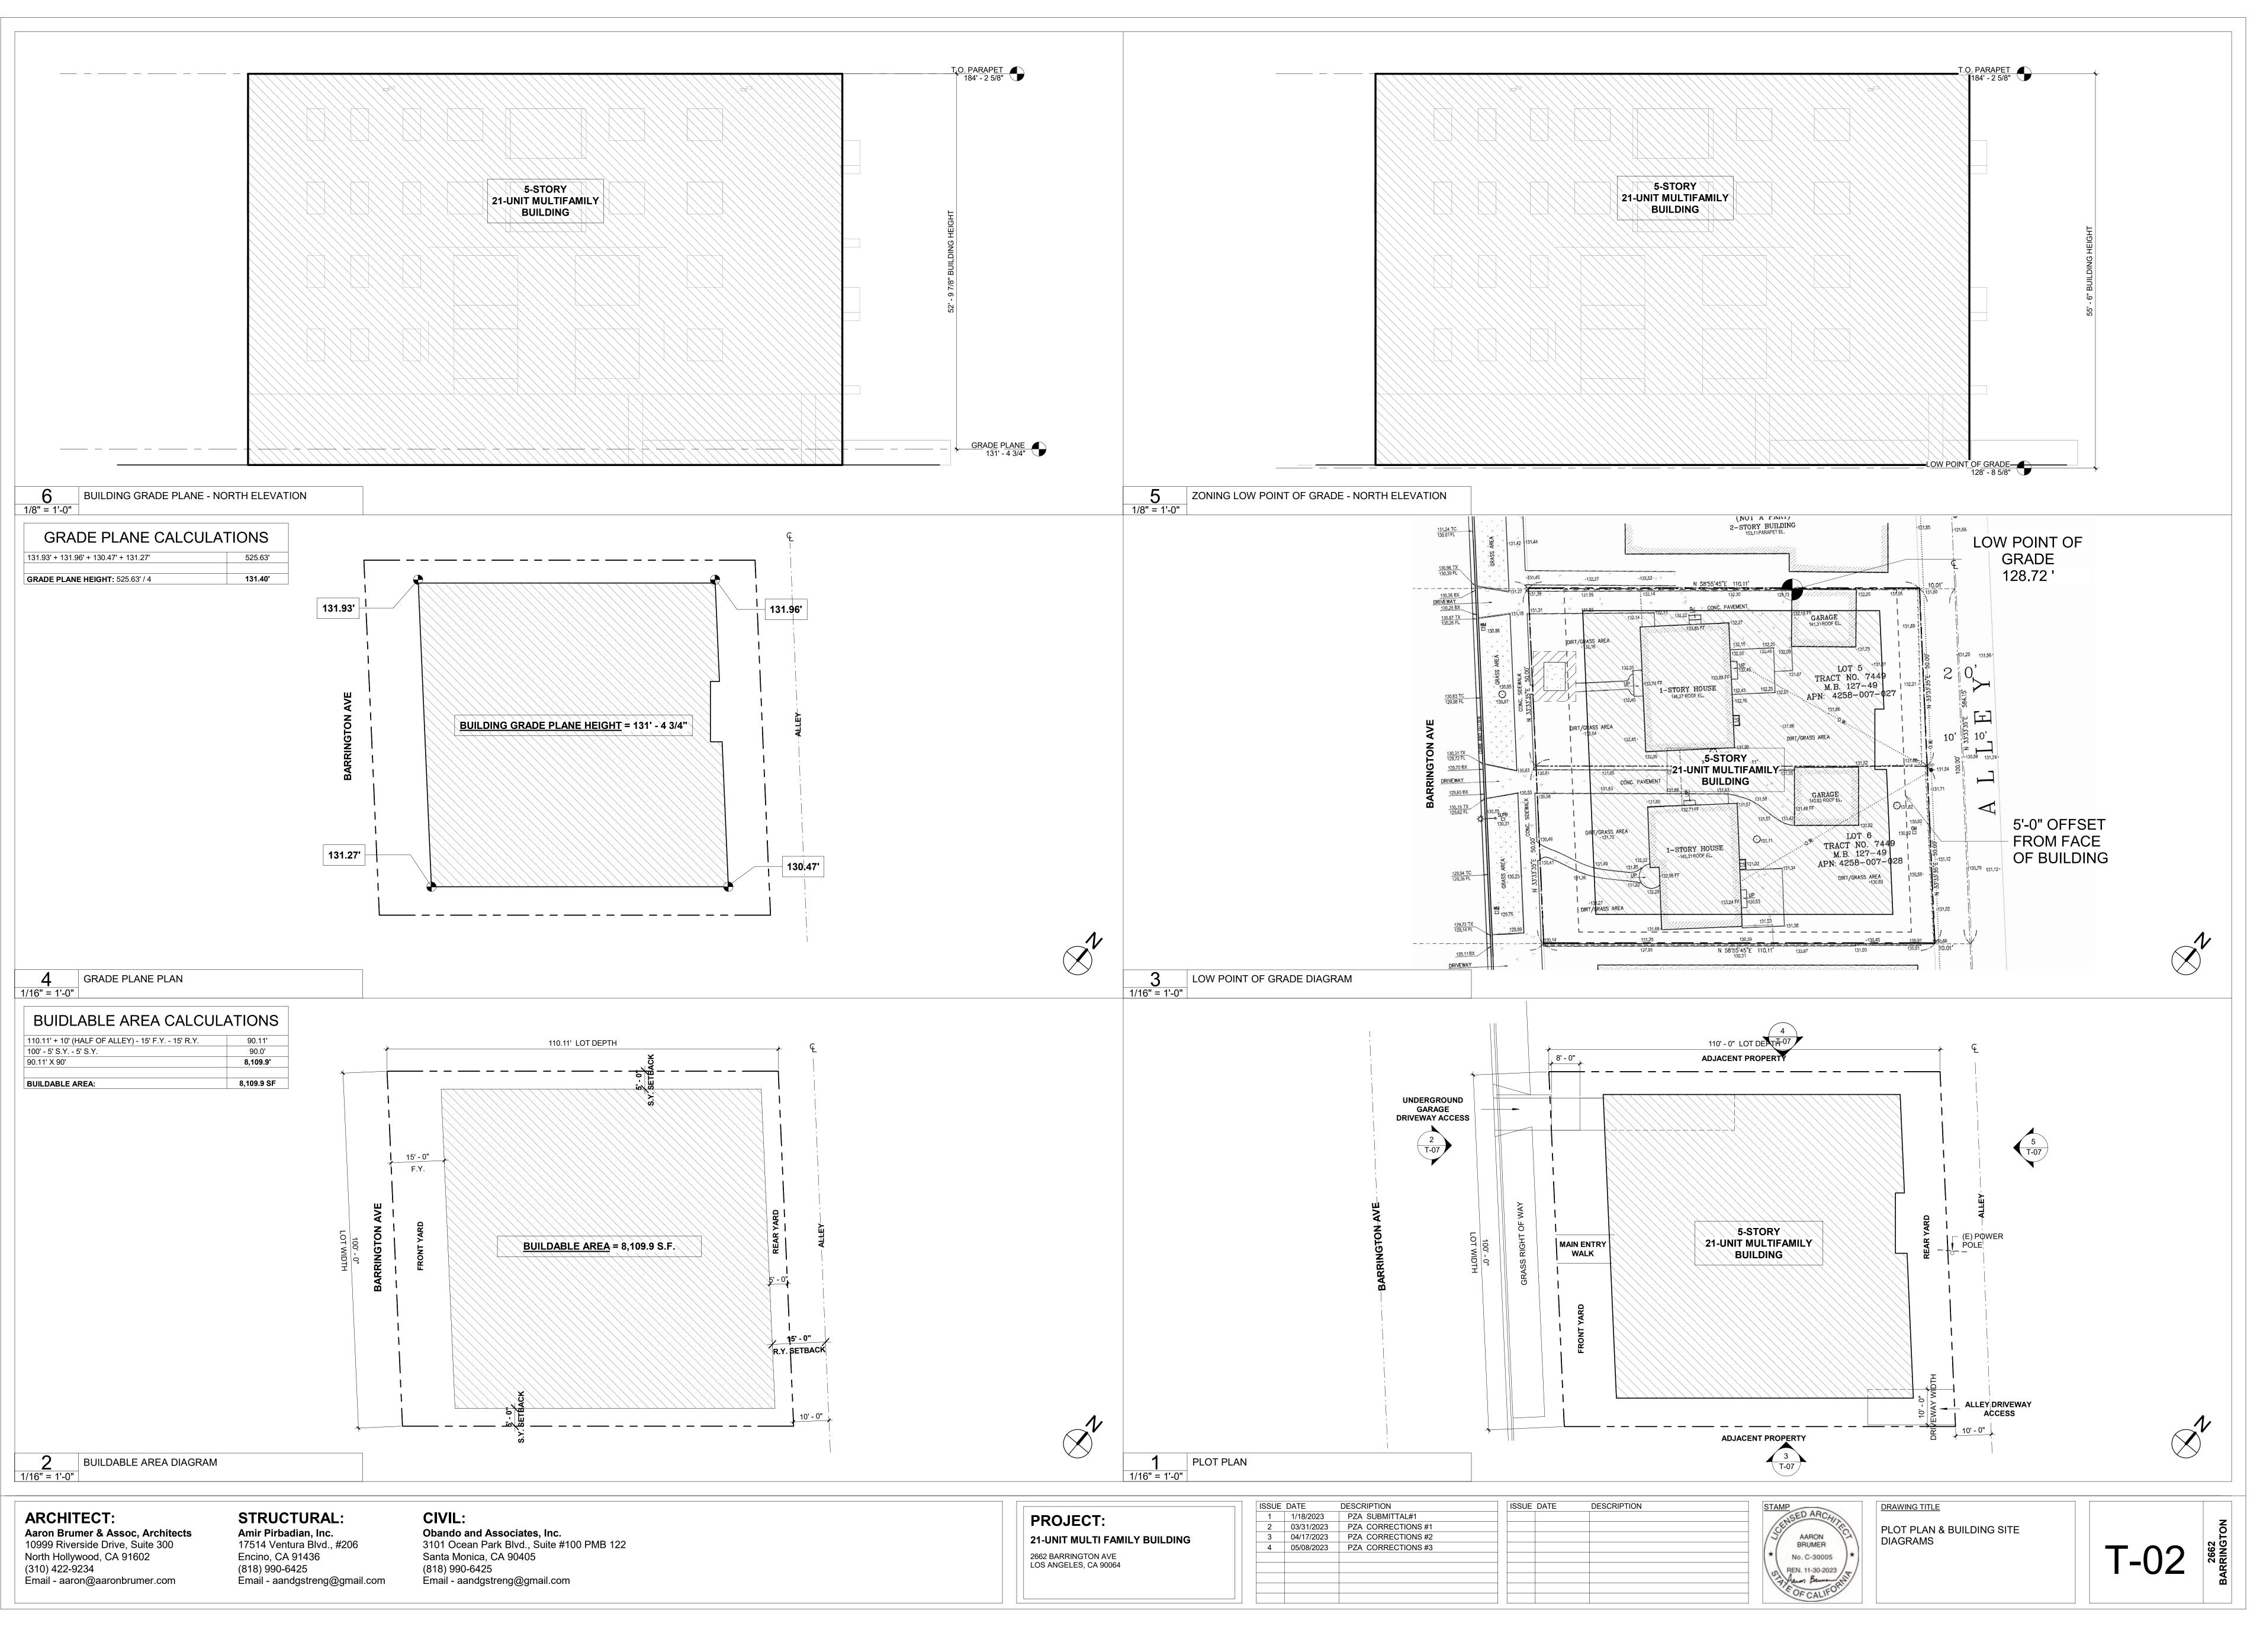


DESCRIPTION	ISSUE DATE	DESCRIPTION	STAMP	DRAWING TITLE
PZA SUBMITTAL#1			SED ARCHIN	
PZA CORRECTIONS #1			Car (m)	PLOT PLAN &
PZA CORRECTIONS #2			J AARON JA	DIAGRAMS
PZA CORRECTIONS #3			BRUMER	DIAGINAINIS
			* No. C-30005 *	
			REN. 11-30-2023	
			Jacon Berner S	
			EOSTIFOR	
			OFCALI	

ZON KEY TAG	ING SF CALCUI BUILDING AREA	ATIONS AREA		
TH FLOOR A B C D E F G H I I	UNIT #401 UNIT #402 UNIT #403 UNIT #404 UNIT #406 HALLWAY BALCONY BALCONY	824.7 SF 923.3 SF 1,229.0 SF 949.9 SF 854.3 SF 1,146.8 SF 402.1 SF 84.7 SF 85.4 SF 6,500.2 SF		
4 6" = 1'-0"				L
KEY TAO ND FLOOR A B	UNIT #201 UNIT #202	AREA 824.7 SF 923.3 SF	[
C D E G H I J K	REC ROOM #203UNIT #204UNIT #205REC ROOM #206REC ROOM #207HALLWAYAreaBALCONYBALCONY	1,229.0 SF 949.9 SF 854.3 SF 607.6 SF 588.4 SF 402.1 SF 85.4 SF 19.5 SF 6,503.7 SF		
			ELEVATOR (NOT INCLUDED)	

			ALCULATIONS
		5TH FLOOR A UNIT #501 B UNIT #502 C UNIT #503	824.7 923.3 1,229.0
		D UNIT #504 E UNIT #505 F UNIT #506 G HALLWAY H BALCONY I BALCONY TOTAL ZONING SF	949.93 854.33 1,146.83 402.13 84.73 85.43 6,500.23 27,313.23
		1/16" = 1'-0"	- ZONING SF DIAGRAM
H BALCONY 84.7 SF		3RD FLOOR A UNIT #301 B UNIT #302 C UNIT #303 D UNIT #304 E UNIT #305 F REC ROOM	
F UNIT #406 F 1,146.8 SF E 854.3 SF R#1 DT DED)		G REC ROOM H HALLWAY I BALCONY J BALCONY K BALCONY	#307 588.4 402.1 85.4 19.5 6,503.7
DED) STAR #2 (NOT (NOT NC(UDED)) TO NOT DED O2 C UNIT #403 1,229.0 SF D UNIT #404 949.9 SF D 949.9 SF D 949.9 SF			
		1/16" = 1'-0"	- ZONING SF DIAGRAM
			ALCULATIONS DING AREA AREA
K BALCONY BALCONY 19.5 SF 19.5 SF REC ROOM G #207 588.4 SF F 607.6 SF		B TRASH/REC C CONFEREN C BIKE STOR/ D ELECTRICA	ICE ROOM 164.1 S AGE 330.4 S
E UNIT #205 E 854.3 SF I R# DT DED) HALLWAY HALLWAY INCLUDED) I I I I I I I I I I I I I		FLOOR1ST FLOOR2ND FLOOR3RD FLOOR4TH FLOOR5TH FLOORTOTAL	NING SF SUMMA AREA
02 C REC ROOM () #203 1,229.0 SF D UNIT #204 949.9 SF			
	X	1/16" = 1'-0"	PARKING PLAN - ZONING
2	PROJECT: 21-UNIT MULTI FAN 2662 BARRINGTON AVE LOS ANGELES, CA 90064		ISSUE DATE DESCR 1 1/18/2023 PZA 2 03/31/2023 PZA 3 04/17/2023 PZA 4 05/08/2023 PZA - - - - - - - - -




824.7 SF
923.3 SF
1,229.0 SF
949.9 SF
854.3 SF
1,146.8 SF
402.1 SF
84.7 SF
85.4 SF
6,500.2 SF
27,313.2 SF

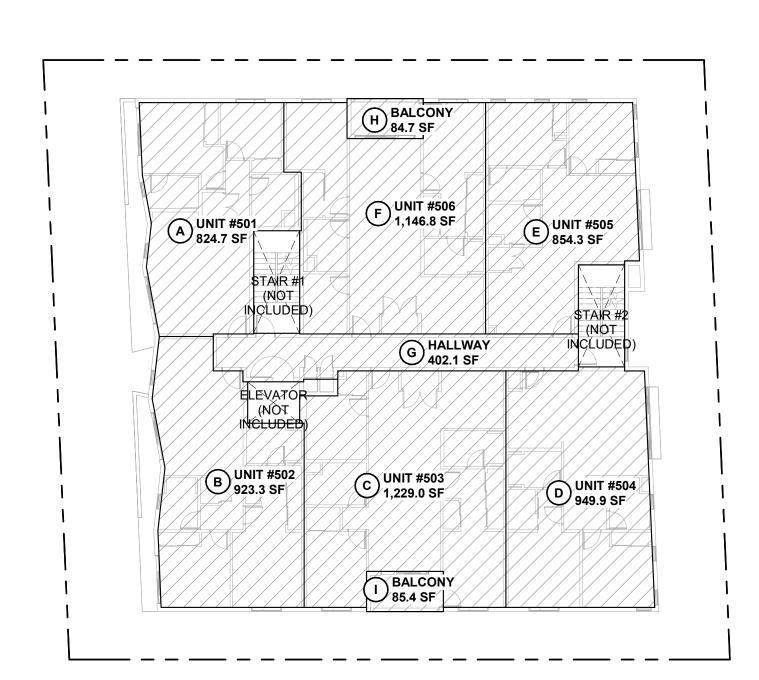

AGRAM


IONS AREA


824.7 SF 923.3 SF 1,229.0 SF 949.9 SF 854.3 SF 607.6 SF 588.4 SF 402.1 SF 85.4 SF 19.5 SF 19.5 SF 19.5 SF 6,503.7 SF

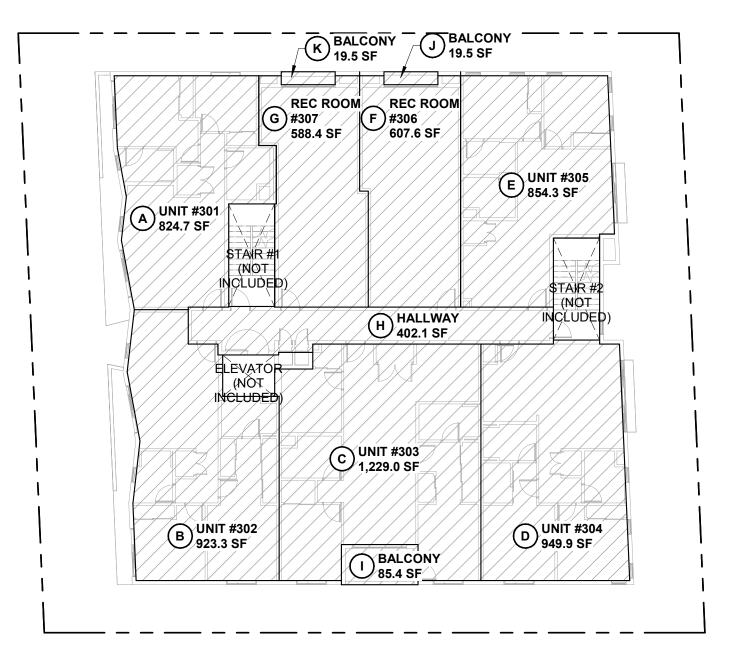

IONS AREA


555.2 SF 183.9 SF 164.1 SF 330.4 SF 71.8 SF 1,305.4 SF

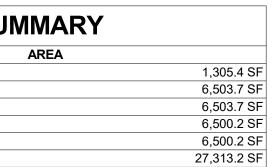

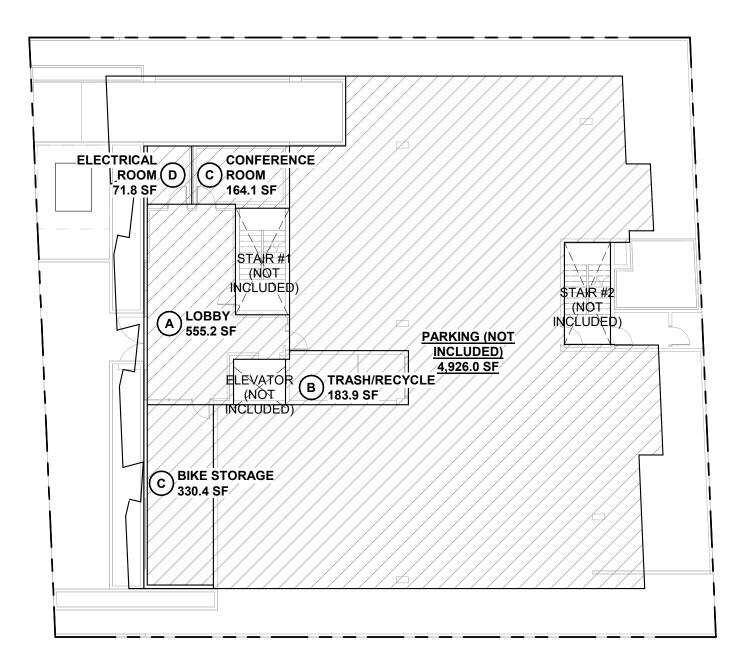

- ZONING SF DIAGRAM


DESCRIPTION	ISSUE DATE DESCRIPTION	STAMP	DRAWING TITLE
PZA SUBMITTAL#1 3 PZA CORRECTIONS #1 3 PZA CORRECTIONS #2 3 PZA CORRECTIONS #3		AARON BRUMER No. C-30005 REN. 11-30-2023 REN. 11-30-2023 Fr. Auron Bernar OF CALLEORNIT	ZONING SQUARE FOOTAGE DIAGRAMS

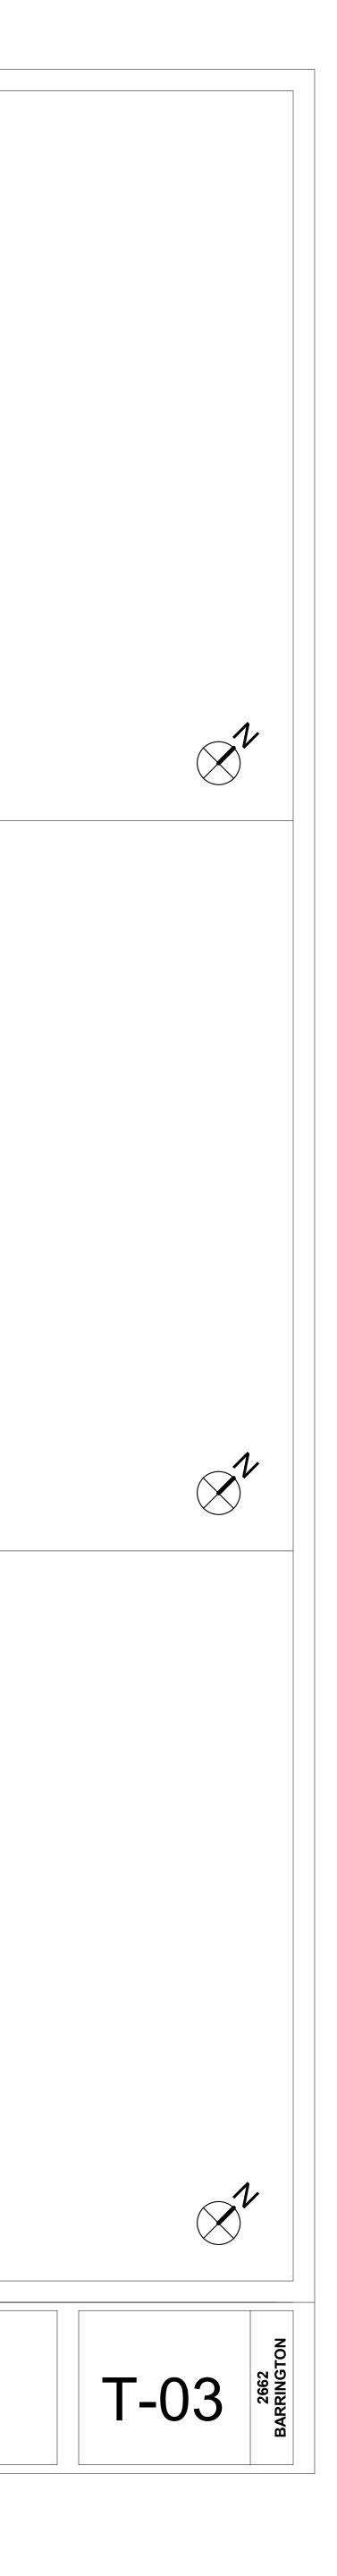


ROOF DECK A	BUILDING AREA OCCUPIABLE ROOF DECK #1	AREA 2,324.1 SF		
		2,324.1 SF 2,324.1 SF		
				27'
			1	
			1	
			1	25'
	1			
<u>6</u> 1/16" = 1'-0"	6TH ROOF DECK - OPEN	SPACE DIAGRAM		
			·	
				L. Y
			, 	
			· 	
			l I	
4 1/16" = 1'-0"	FOURTH FLOOR			
OPEN	SPACE CALCULA	TIONS		
KEY TAG 2ND FLOOR	BUILDING AREA	AREA		
A	REC ROOM #1	600.0 SF 600.0 SF		
			1	
			1 1	
2 1/16" = 1'-0"	SECOND FLOOR			
	TECT:	STRUCTUR	 CIVIL:	





DESCRIPTION	ISSUE DATE DES	CRIPTION	STAMP	DRAWING TITLE
PZA SUBMITTAL#1			NSED ARCHIN	
PZA CORRECTIONS #1			131 33	OPEN SPACE DIAGRAM
PZA CORRECTIONS #2			J AARON ()	
PZA CORRECTIONS #3			BRUMER	
			* No. C-30005 *	
			REN. 11-30-2023	
			Brann Berner S	
			A Marine Car	
			OFCALIF	

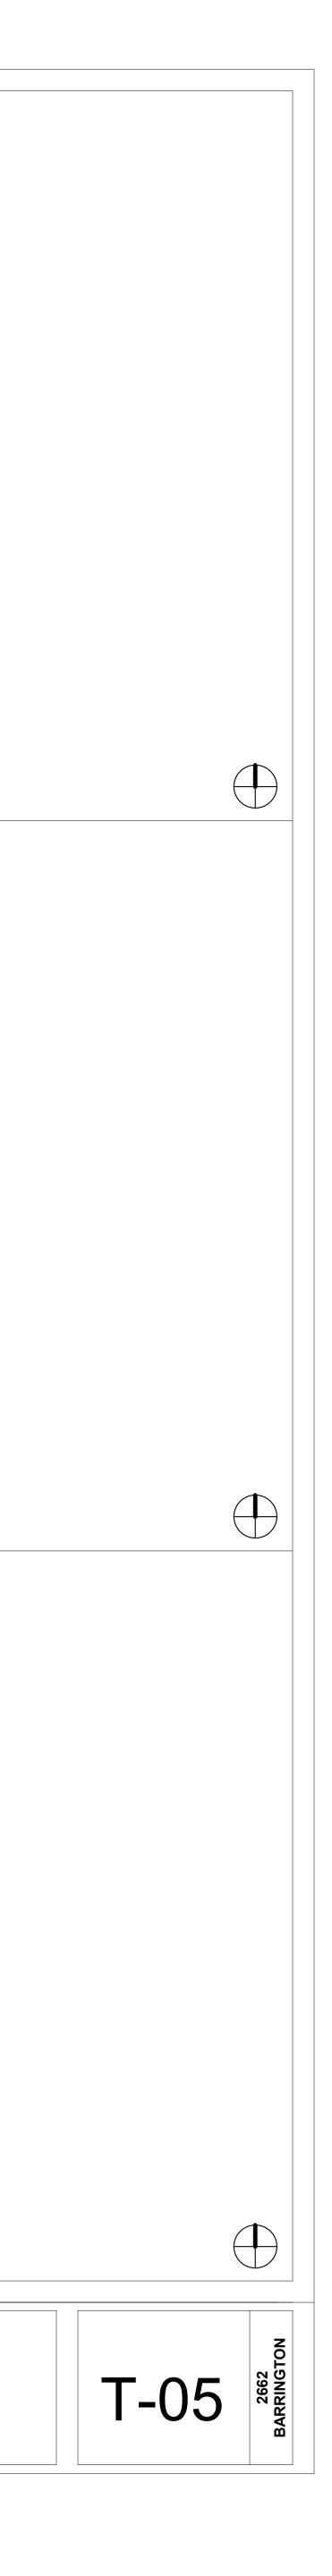

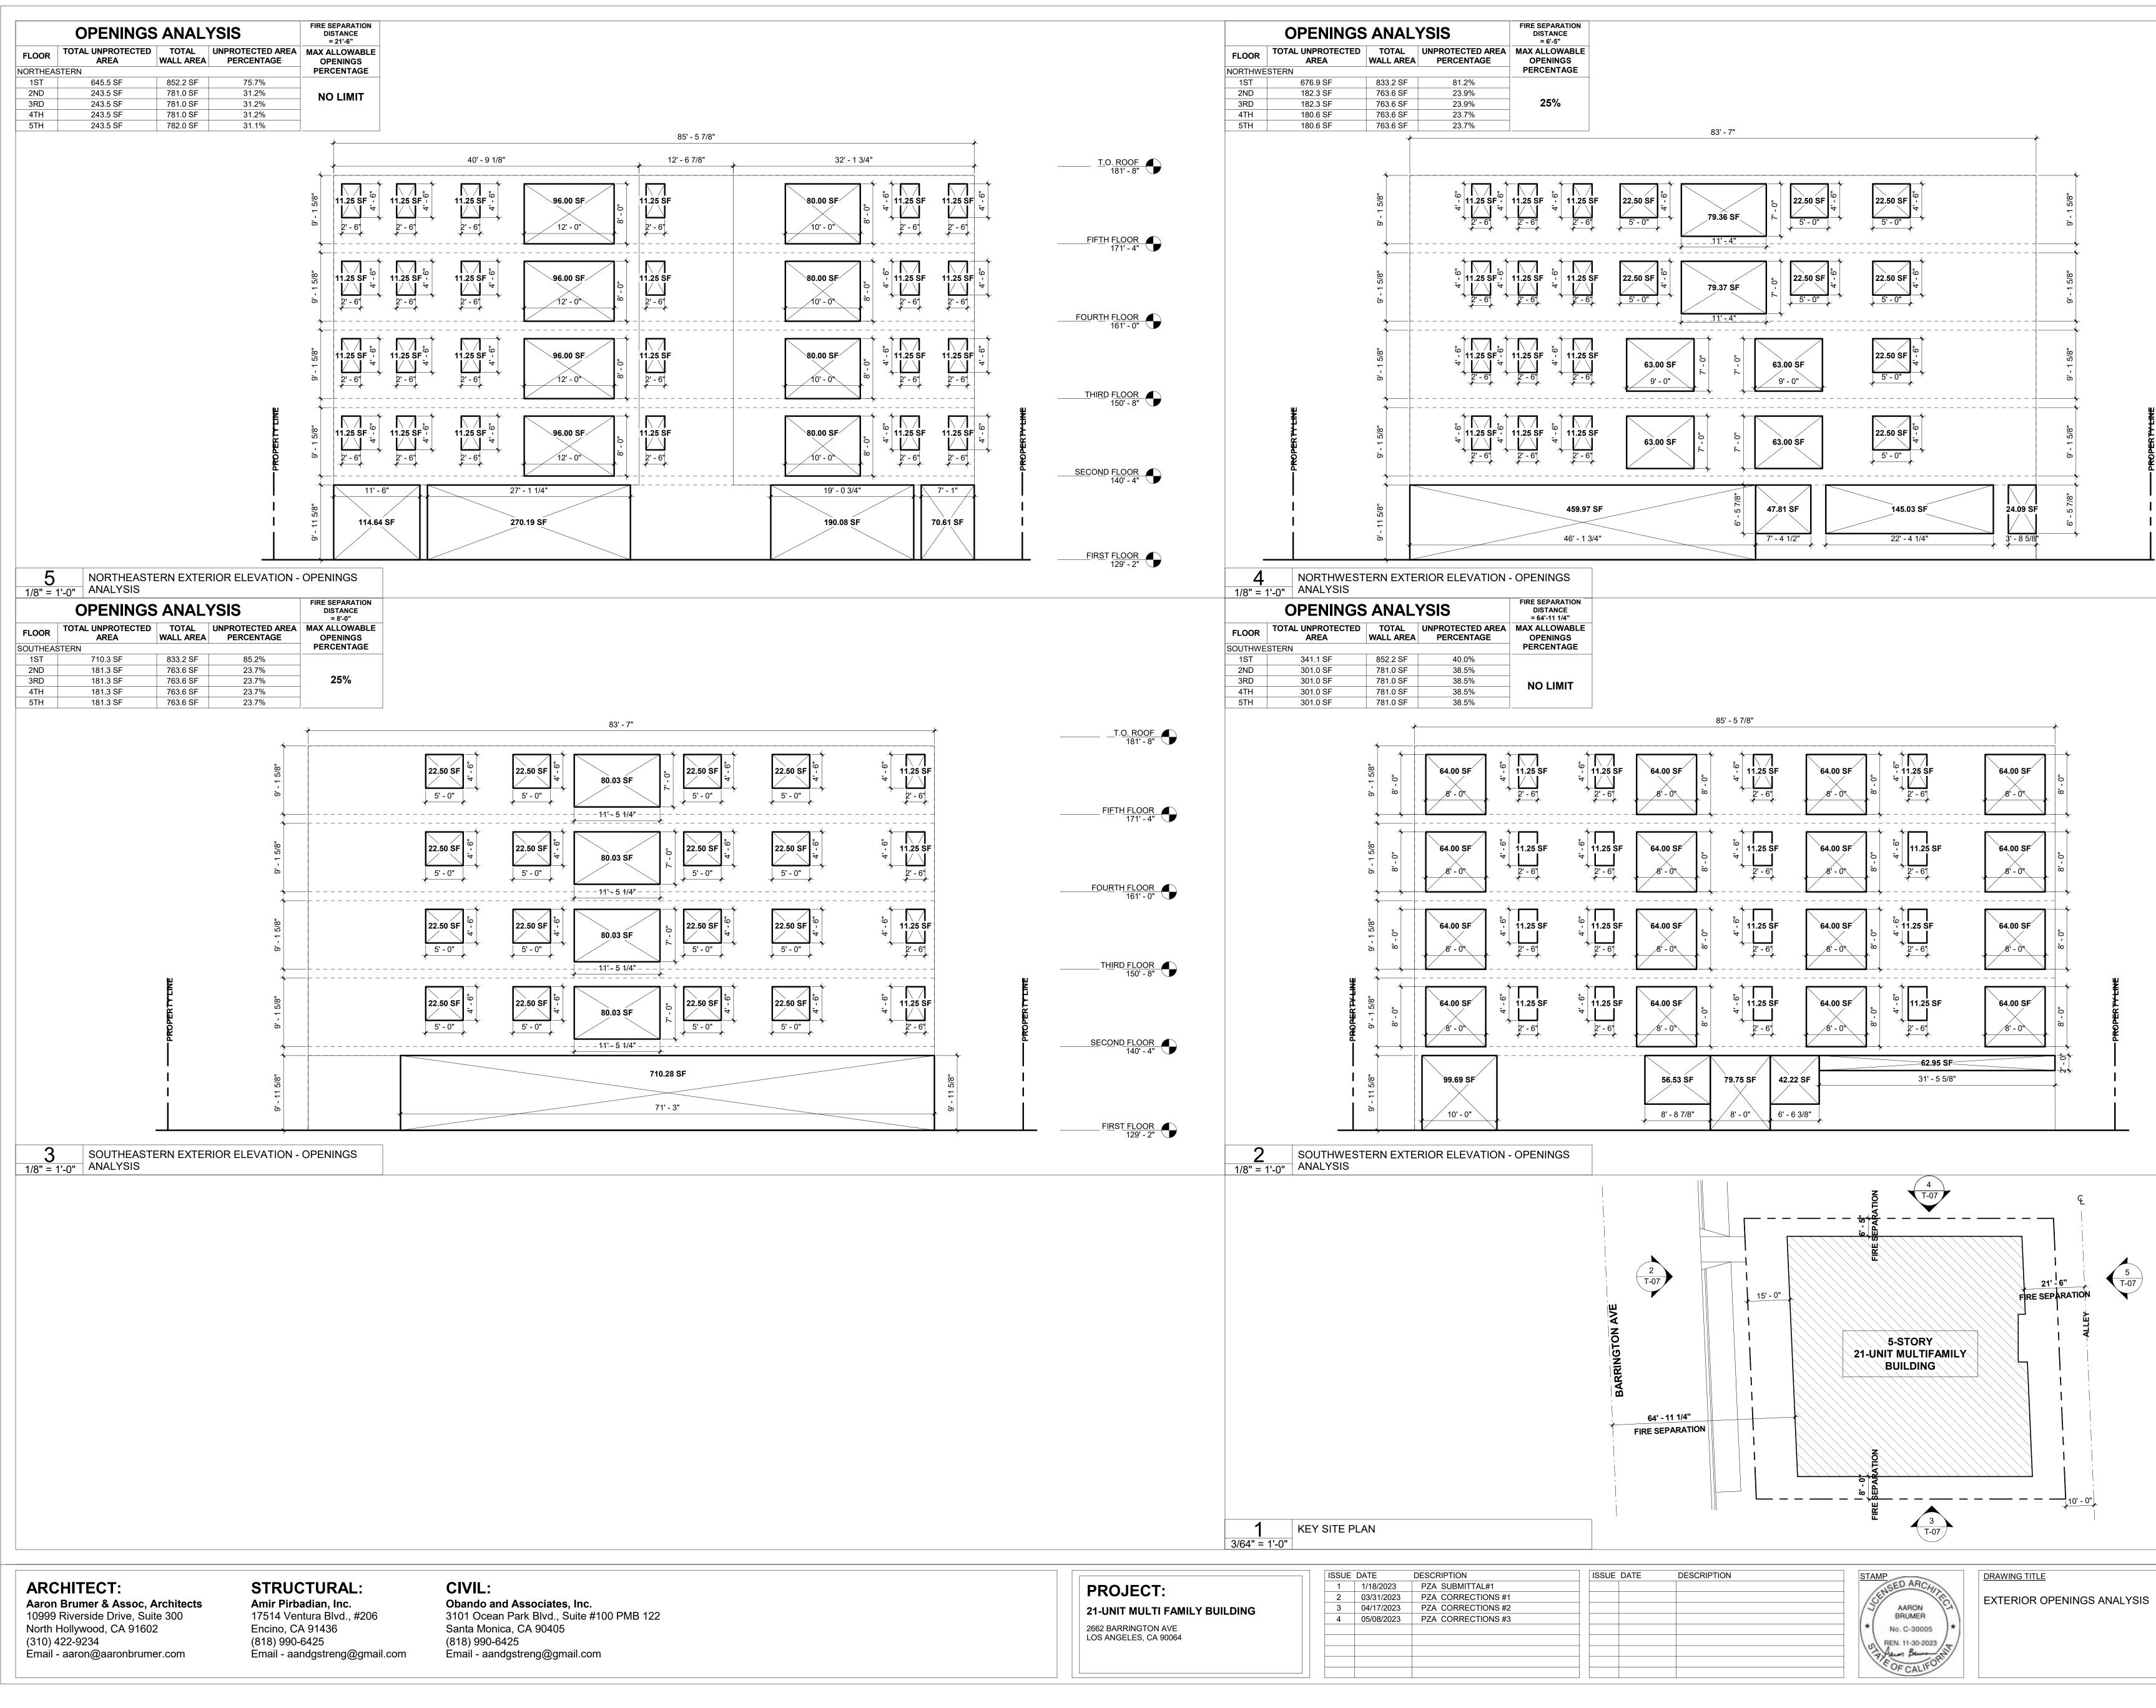


	DESCRIPTION	ISSUE DATE	DESCRIPTION	STAMP	DRAWING TITLE
	PZA SUBMITTAL#1			SED ARCHIN	
}	PZA CORRECTIONS #1			131	EXTERIOR OPENINGS ANAL
3	PZA CORRECTIONS #2			J AARON JA	
3	PZA CORRECTIONS #3			BRUMER	
				* No. C-30005 *	
				REN. 11-30-2023	
				Alar Berne S	
				FOFONIEON	
				OF CAL!	

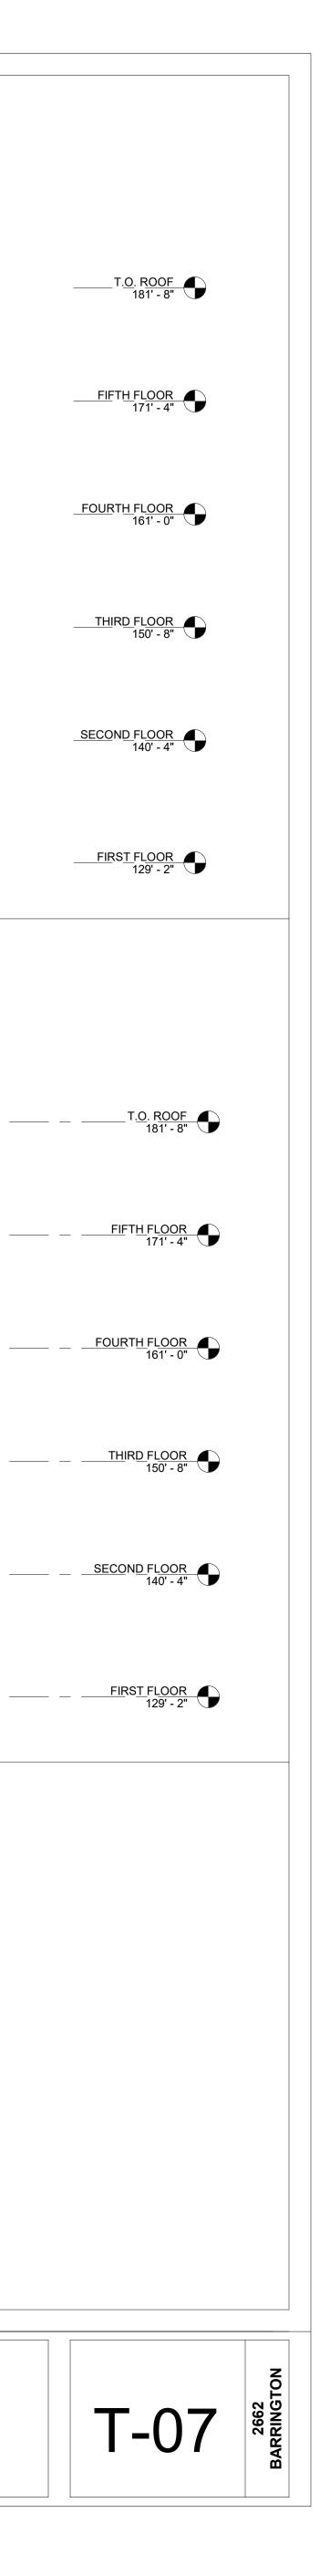


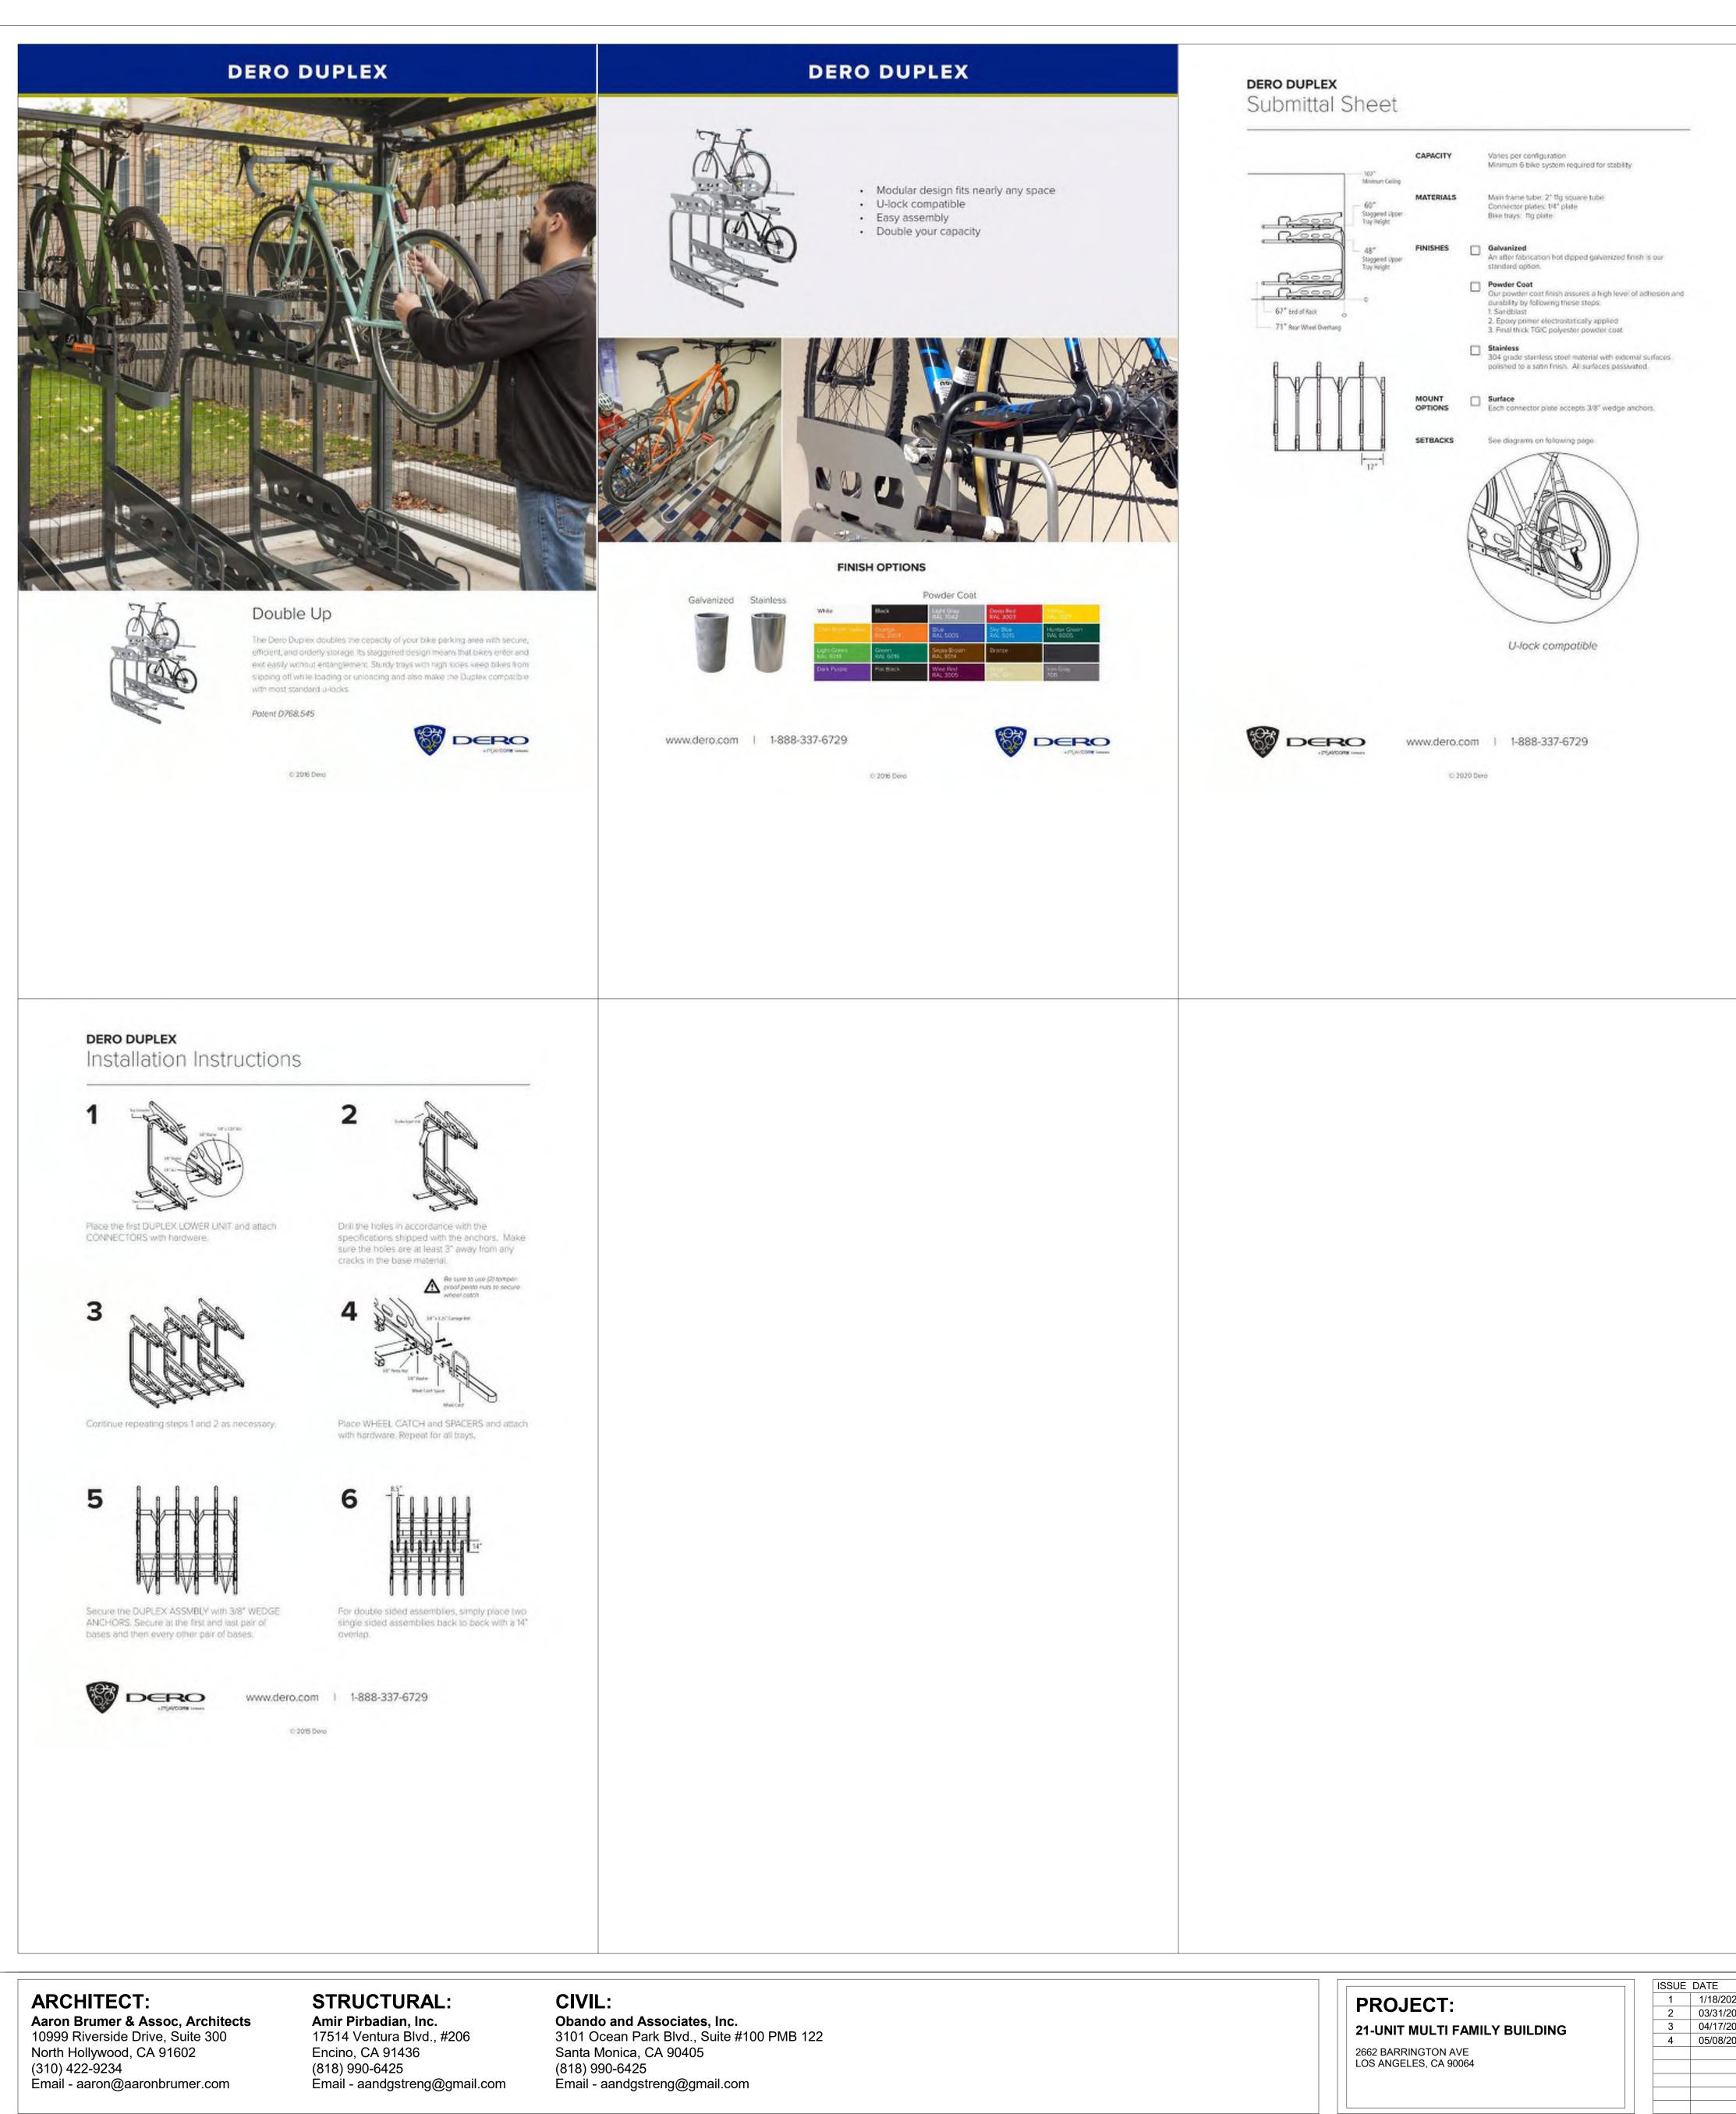

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Submittal	Sheet

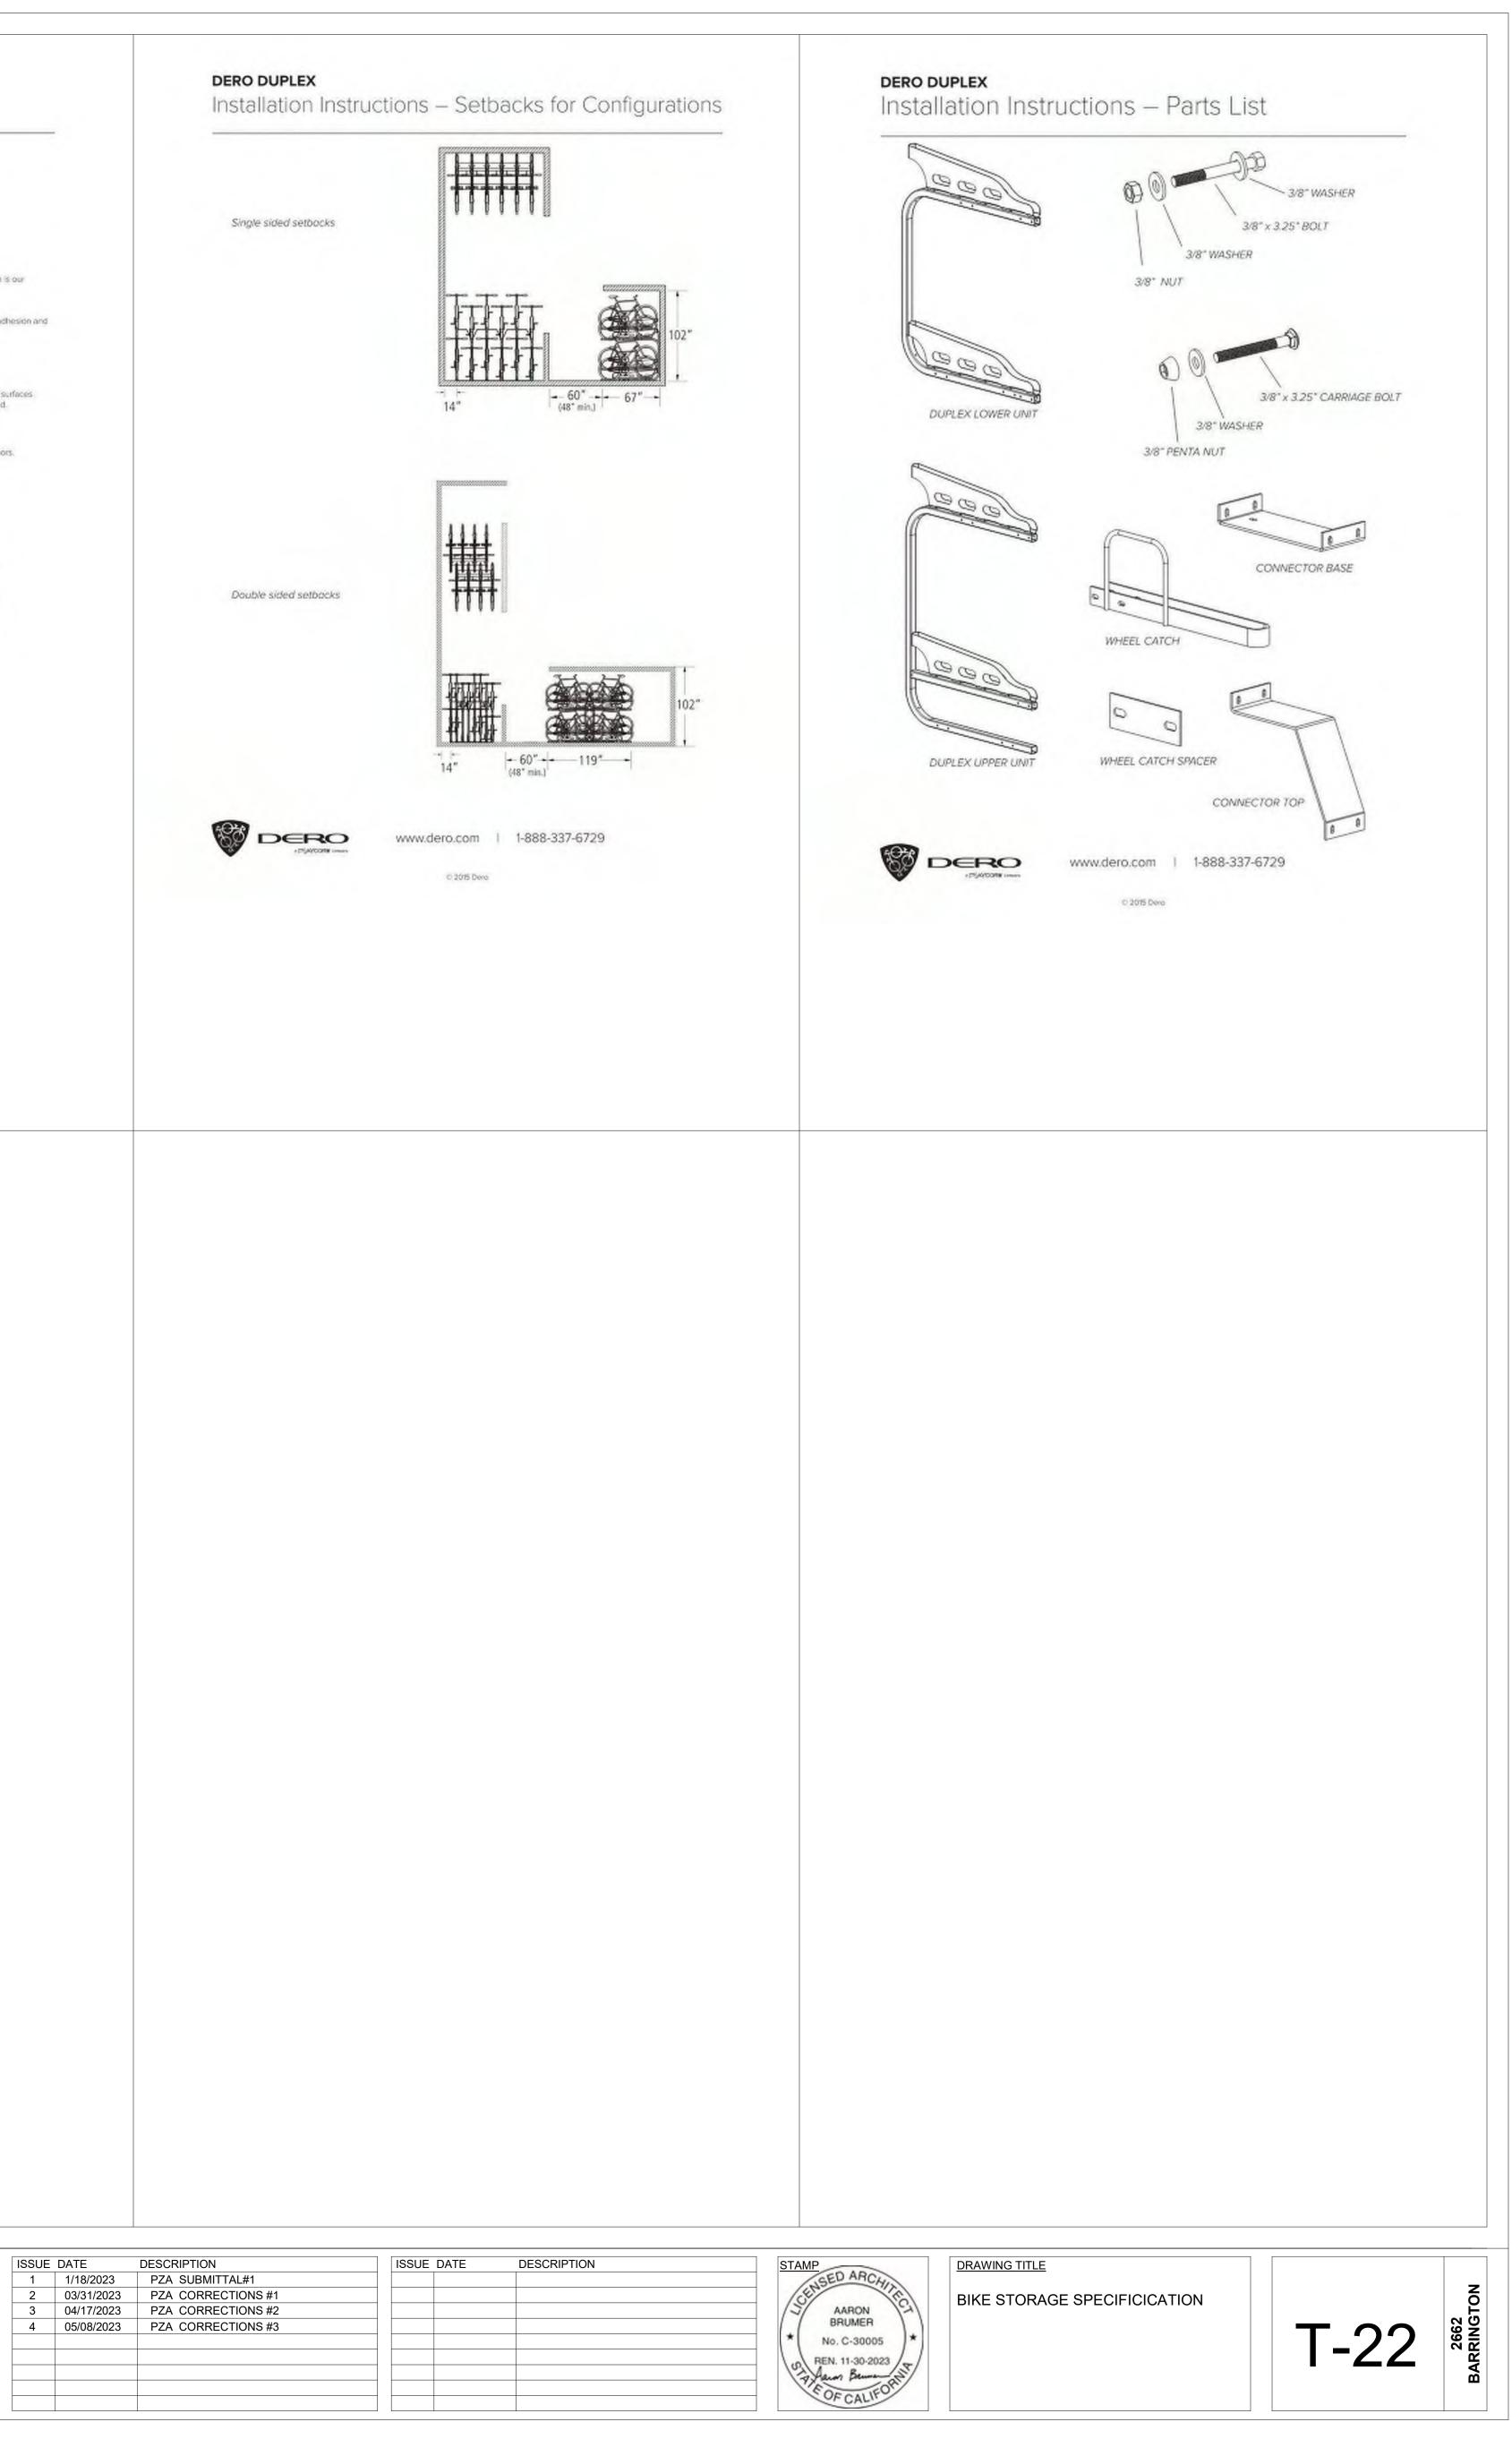


STAMP
 NSED ARCHIN
 Se MARCAN (G)
 BRUMER

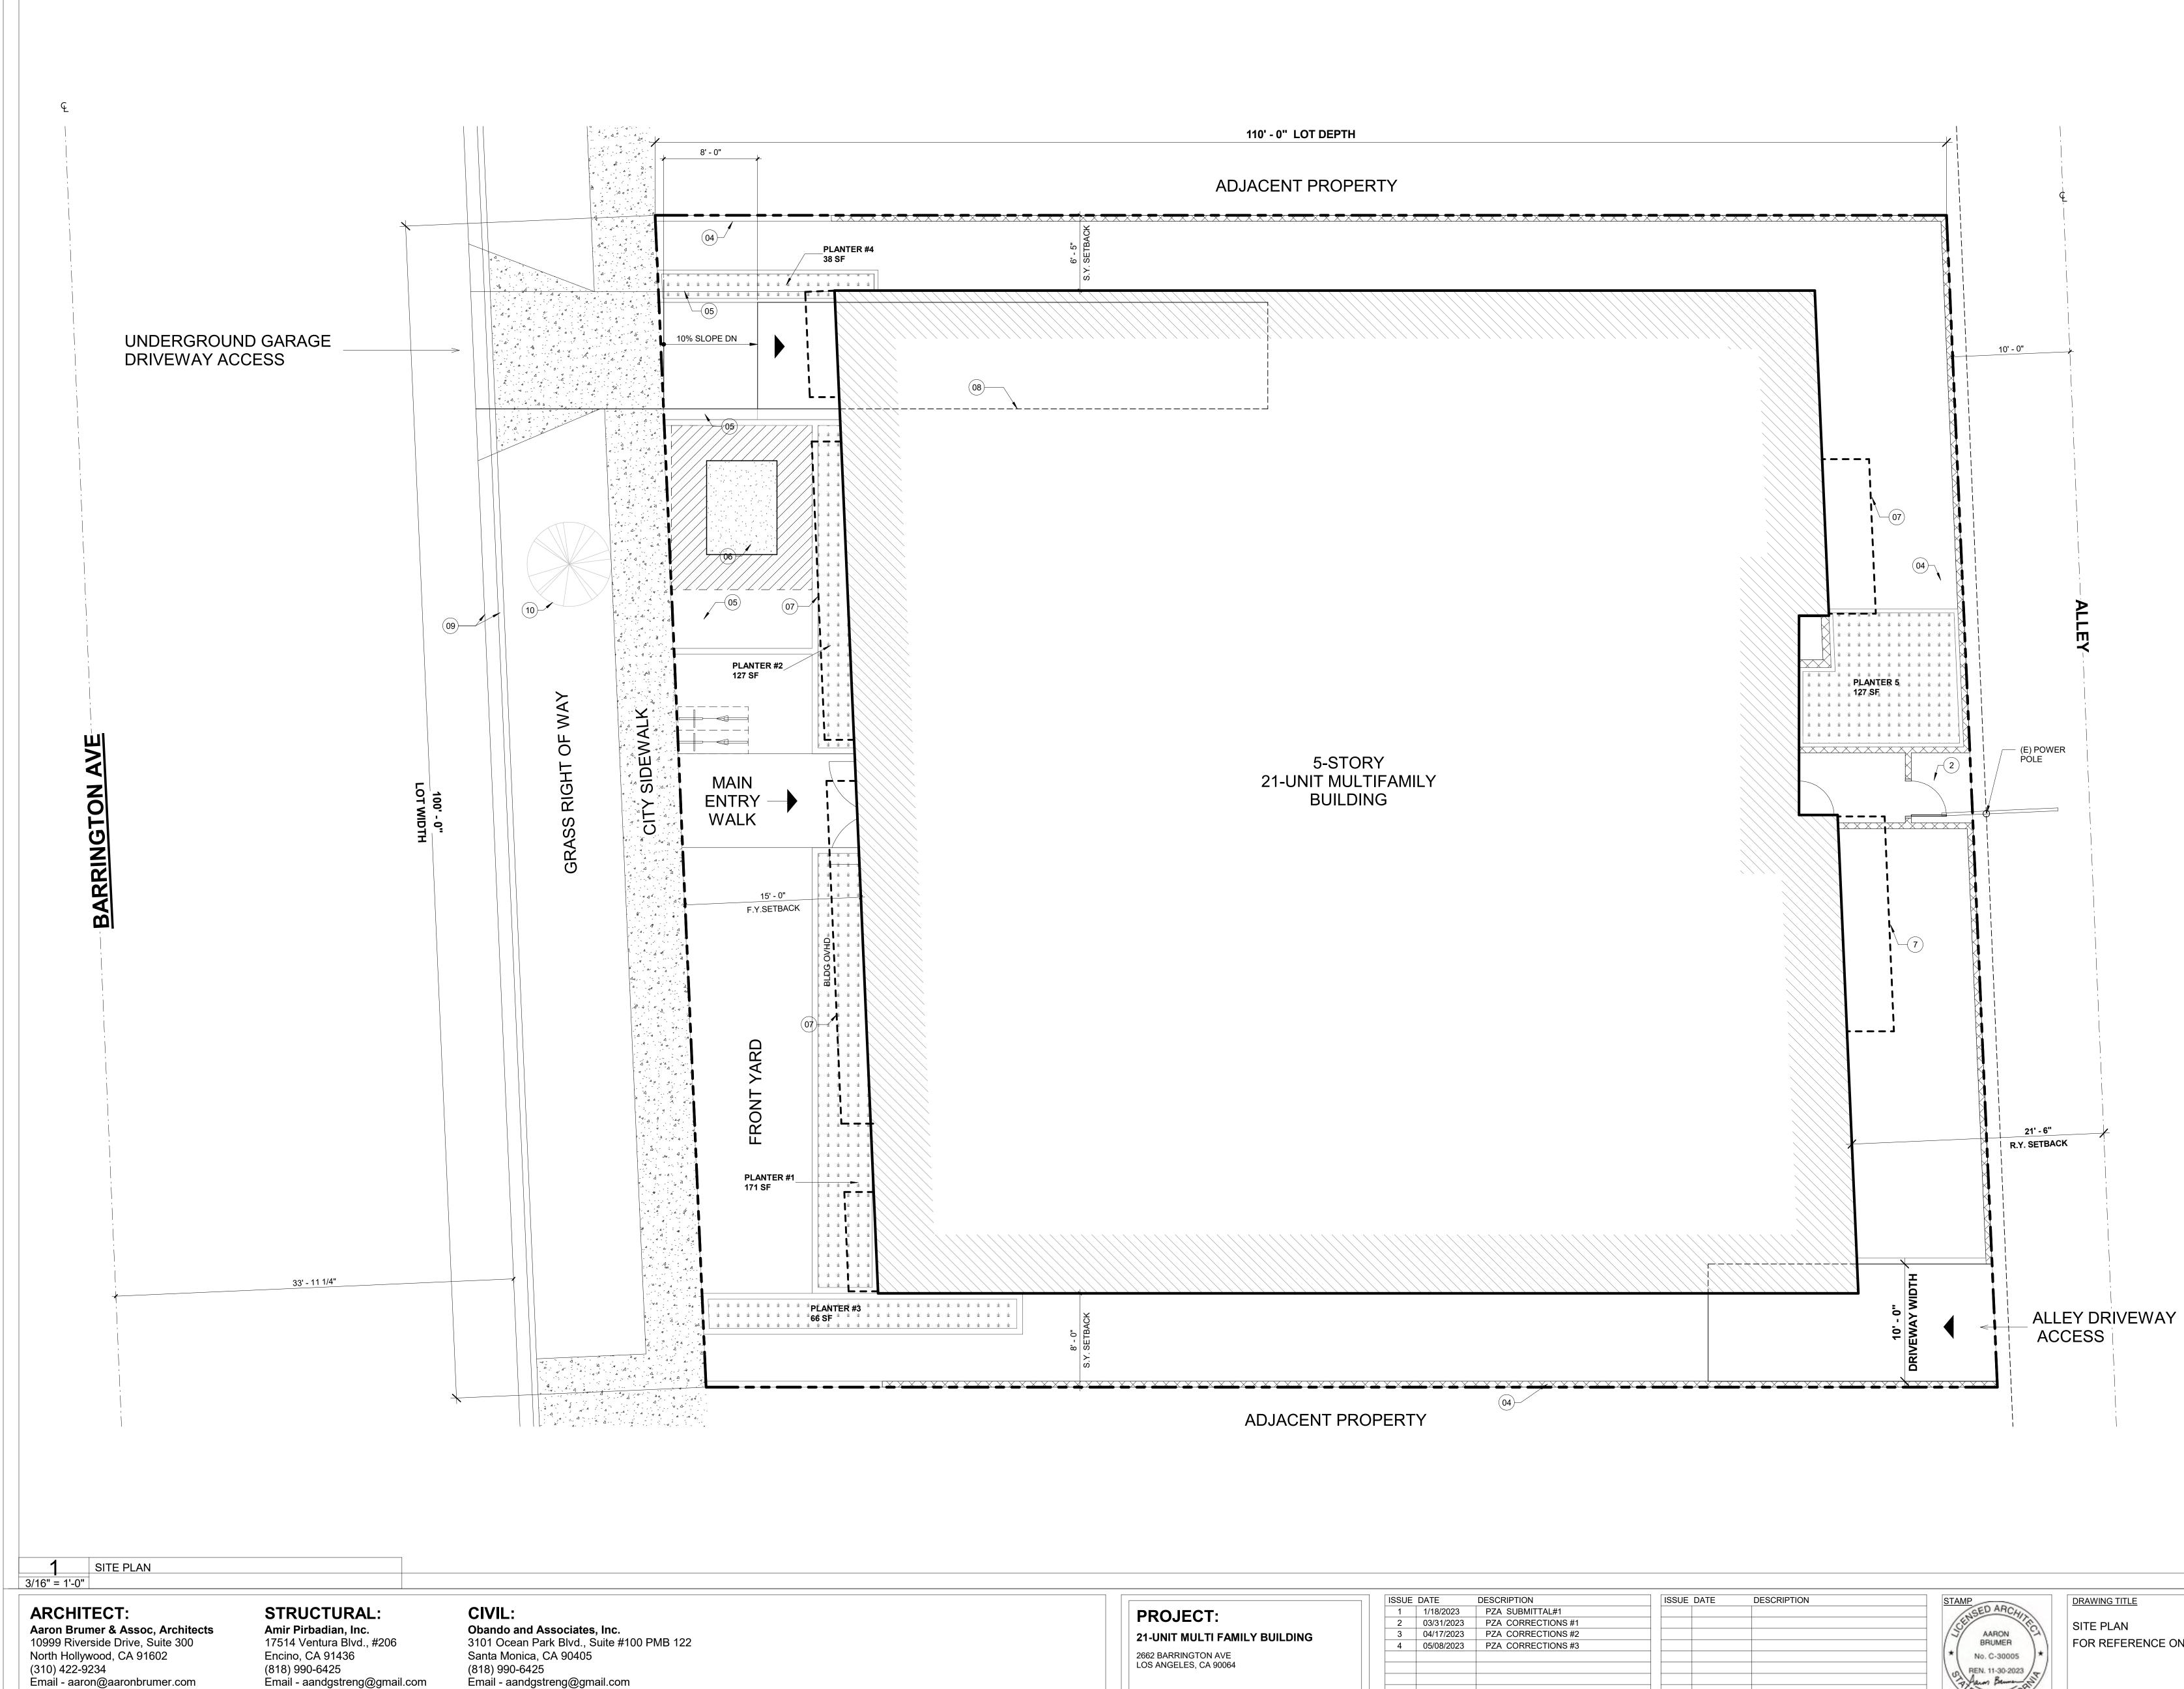

Email - aandgstreng@gmail.com

	1	ISSUE	DATE
PROJECT:		1	1/18/2
FROJECT.		2	03/31
21-UNIT MULTI FAMILY BUILDING		3	04/17
		4	05/08
2662 BARRINGTON AVE			
LOS ANGELES, CA 90064			

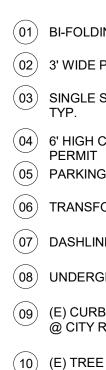

DESCRIPTION ISSUE DATE DESCRIPTION	STAMP DRAWING TITLE
PZA SUBMITTAL#1	SED ARCAY
PZA CORRECTIONS #1	SITE PLAN
PZA CORRECTIONS #2	J AARON A
PZA CORRECTIONS #3	
	* No. C-30005 *
	BEN. 11-30-2023
	Jaim Berner St
	E OF ON IFOR
	CALI

ENCE ONLY

(01) BI-FOLDING REMOTE GARAGE ENTRY GATE (02) 3' WIDE PEDESTRIAN GATE

(03) SINGLE SHORT-TERM BICYCLE PARKING SPACE, TYP.

04 6' HIGH CMU PERIMETER WALL (UNDER SEPARATE (05) PARKING GARAGE CMU WALL


(06) TRANSFORMER CONC. PAD

(07) DASHLINES INDICATES THE OVERHANG ABOVE (08) UNDERGROUND GARAGE DRIVEWAY


(09) (E) CURB AND GUTTER TO PROTECT IN PLACE @ CITY RIGHT OF WAY

(E) TREE TO PROTECT IN PLACE @ CITY RIGHT OF WAY



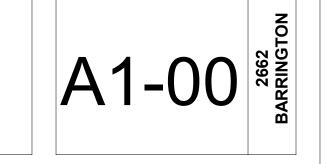


ARCHITECT: Aaron Brumer & Assoc, Architects 10999 Riverside Drive, Suite 300	STRUCTURAL: Amir Pirbadian, Inc. 17514 Ventura Blvd., #206	CIVIL: Obando and Associates, Inc. 3101 Ocean Park Blvd., Suite #100 PME
1 BASEMENT PARKING PLAN 3/16" = 1'-0" KEYNOTES		LEGEN
A4-01		
A4-05		
		TRANSFOR
1 A4-04		

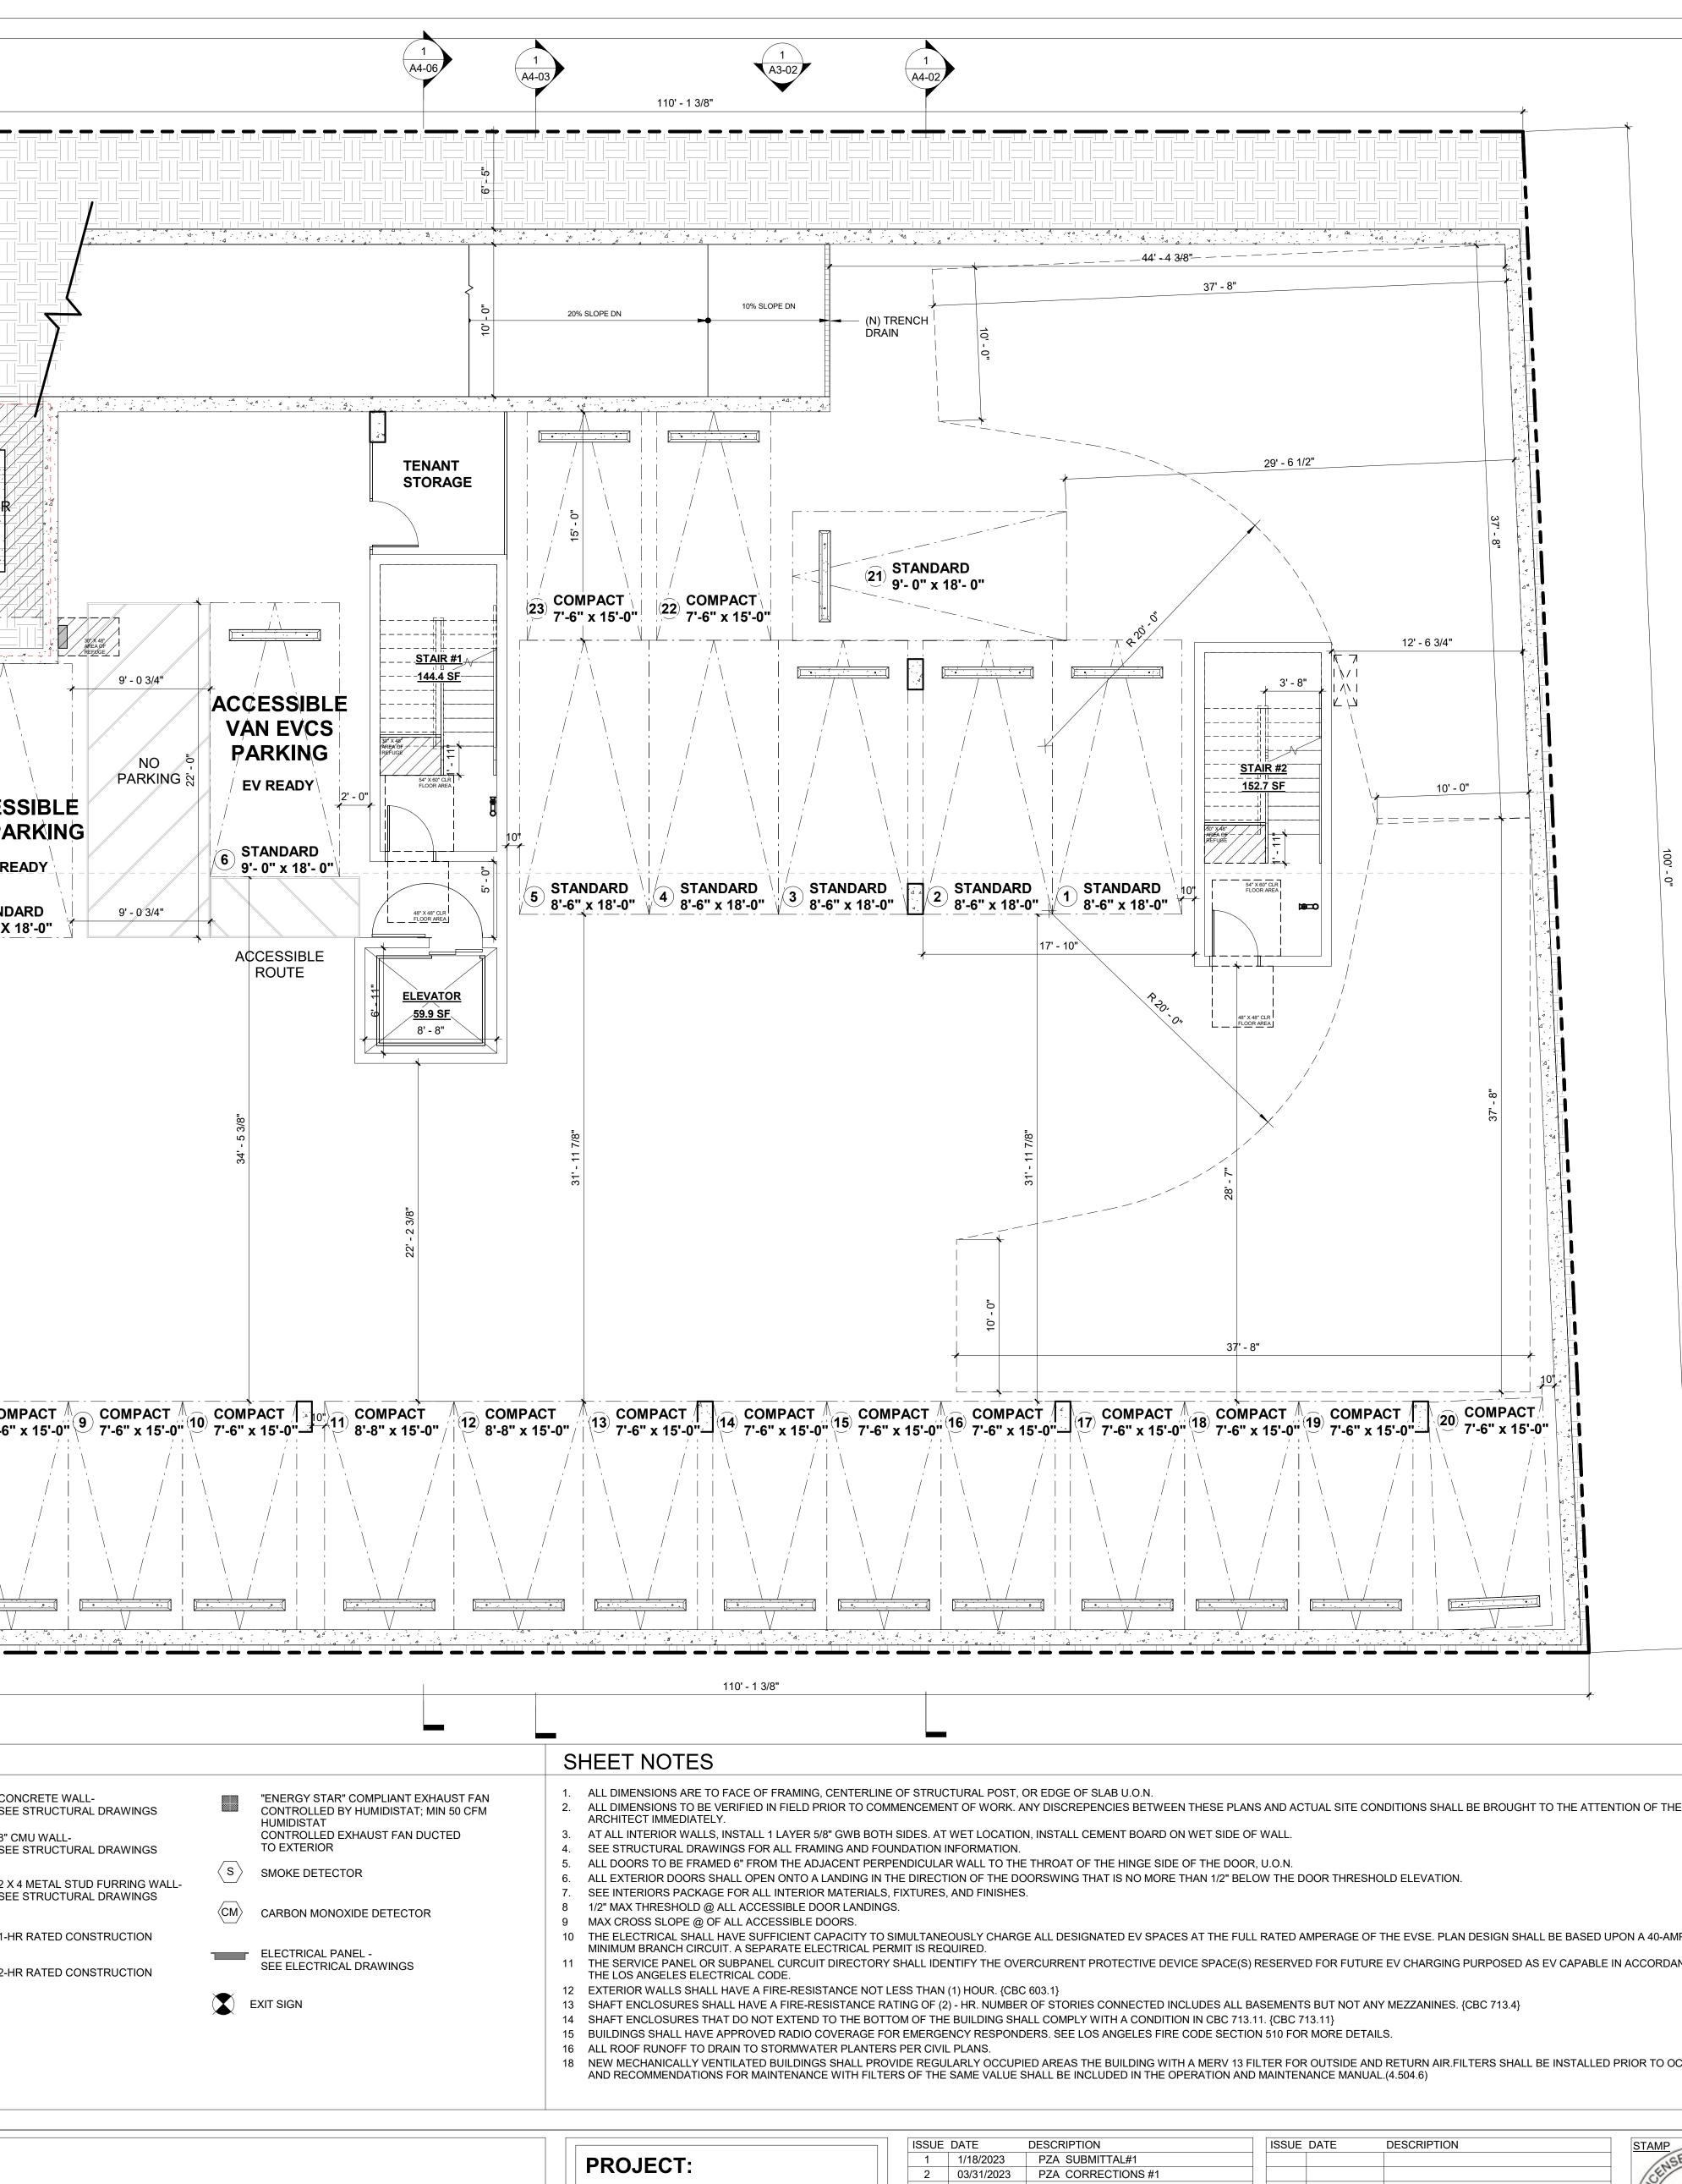


21-UNIT MULTI FAMILY BUILDING
2662 BARRINGTON AVE LOS ANGELES, CA 90064


SSUE	DATE	DESCRIPTION	ISSUE	DATE	DESCRIPTION
1	1/18/2023	PZA SUBMITTAL#1			
2	03/31/2023	PZA CORRECTIONS #1			
3	04/17/2023	PZA CORRECTIONS #2			
4	05/08/2023	PZA CORRECTIONS #3			

						KEY PL
, OR EDGE OF SLAB U.O.N. ANY DISCREPENCIES BETWEEN THESE PLAN	S AND ACTUAL SITE (CONDITIONS SHALL BE BRC	UGHT TO THE ATTEN	TION OF THE		
ON, INSTALL CEMENT BOARD ON WET SIDE OF	WALL.					
HE THROAT OF THE HINGE SIDE OF THE DOOR DOORSWING THAT IS NO MORE THAN 1/2" BELC ES.		SHOLD ELEVATION.				
GE ALL DESIGNATED EV SPACES AT THE FULL	RATED AMPERAGE	OF THE EVSE. PLAN DESIGN	N SHALL BE BASED UF	ON A 40-AMPERE		
/ERCURRENT PROTECTIVE DEVICE SPACE(S) I	RESERVED FOR FUTU	JRE EV CHARGING PURPOS	SED AS EV CAPABLE I	N ACCORDANCE WITH		
3C 603.1} ER OF STORIES CONNECTED INCLUDES ALL BA HALL COMPLY WITH A CONDITION IN CBC 713.1 IDERS. SEE LOS ANGELES FIRE CODE SECTION	1. {CBC 713.11}		3.4}			
PIED AREAS THE BUILDING WITH A MERV 13 FI SHALL BE INCLUDED IN THE OPERATION AND			HALL BE INSTALLED I	PRIOR TO OCCUPANCY		
DESCRIPTION	ISSUE DATE	DESCRIPTION		STAMP	DRAWING TITLE	

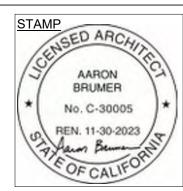


BASEMENT PARKING PLAN

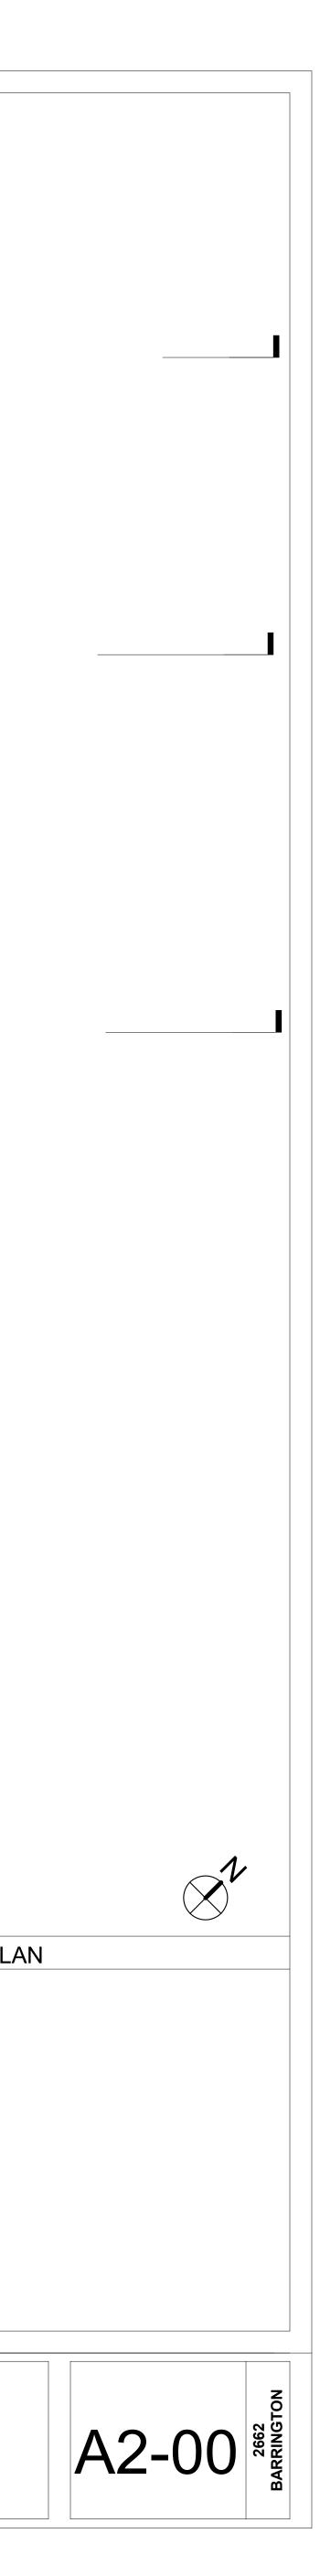


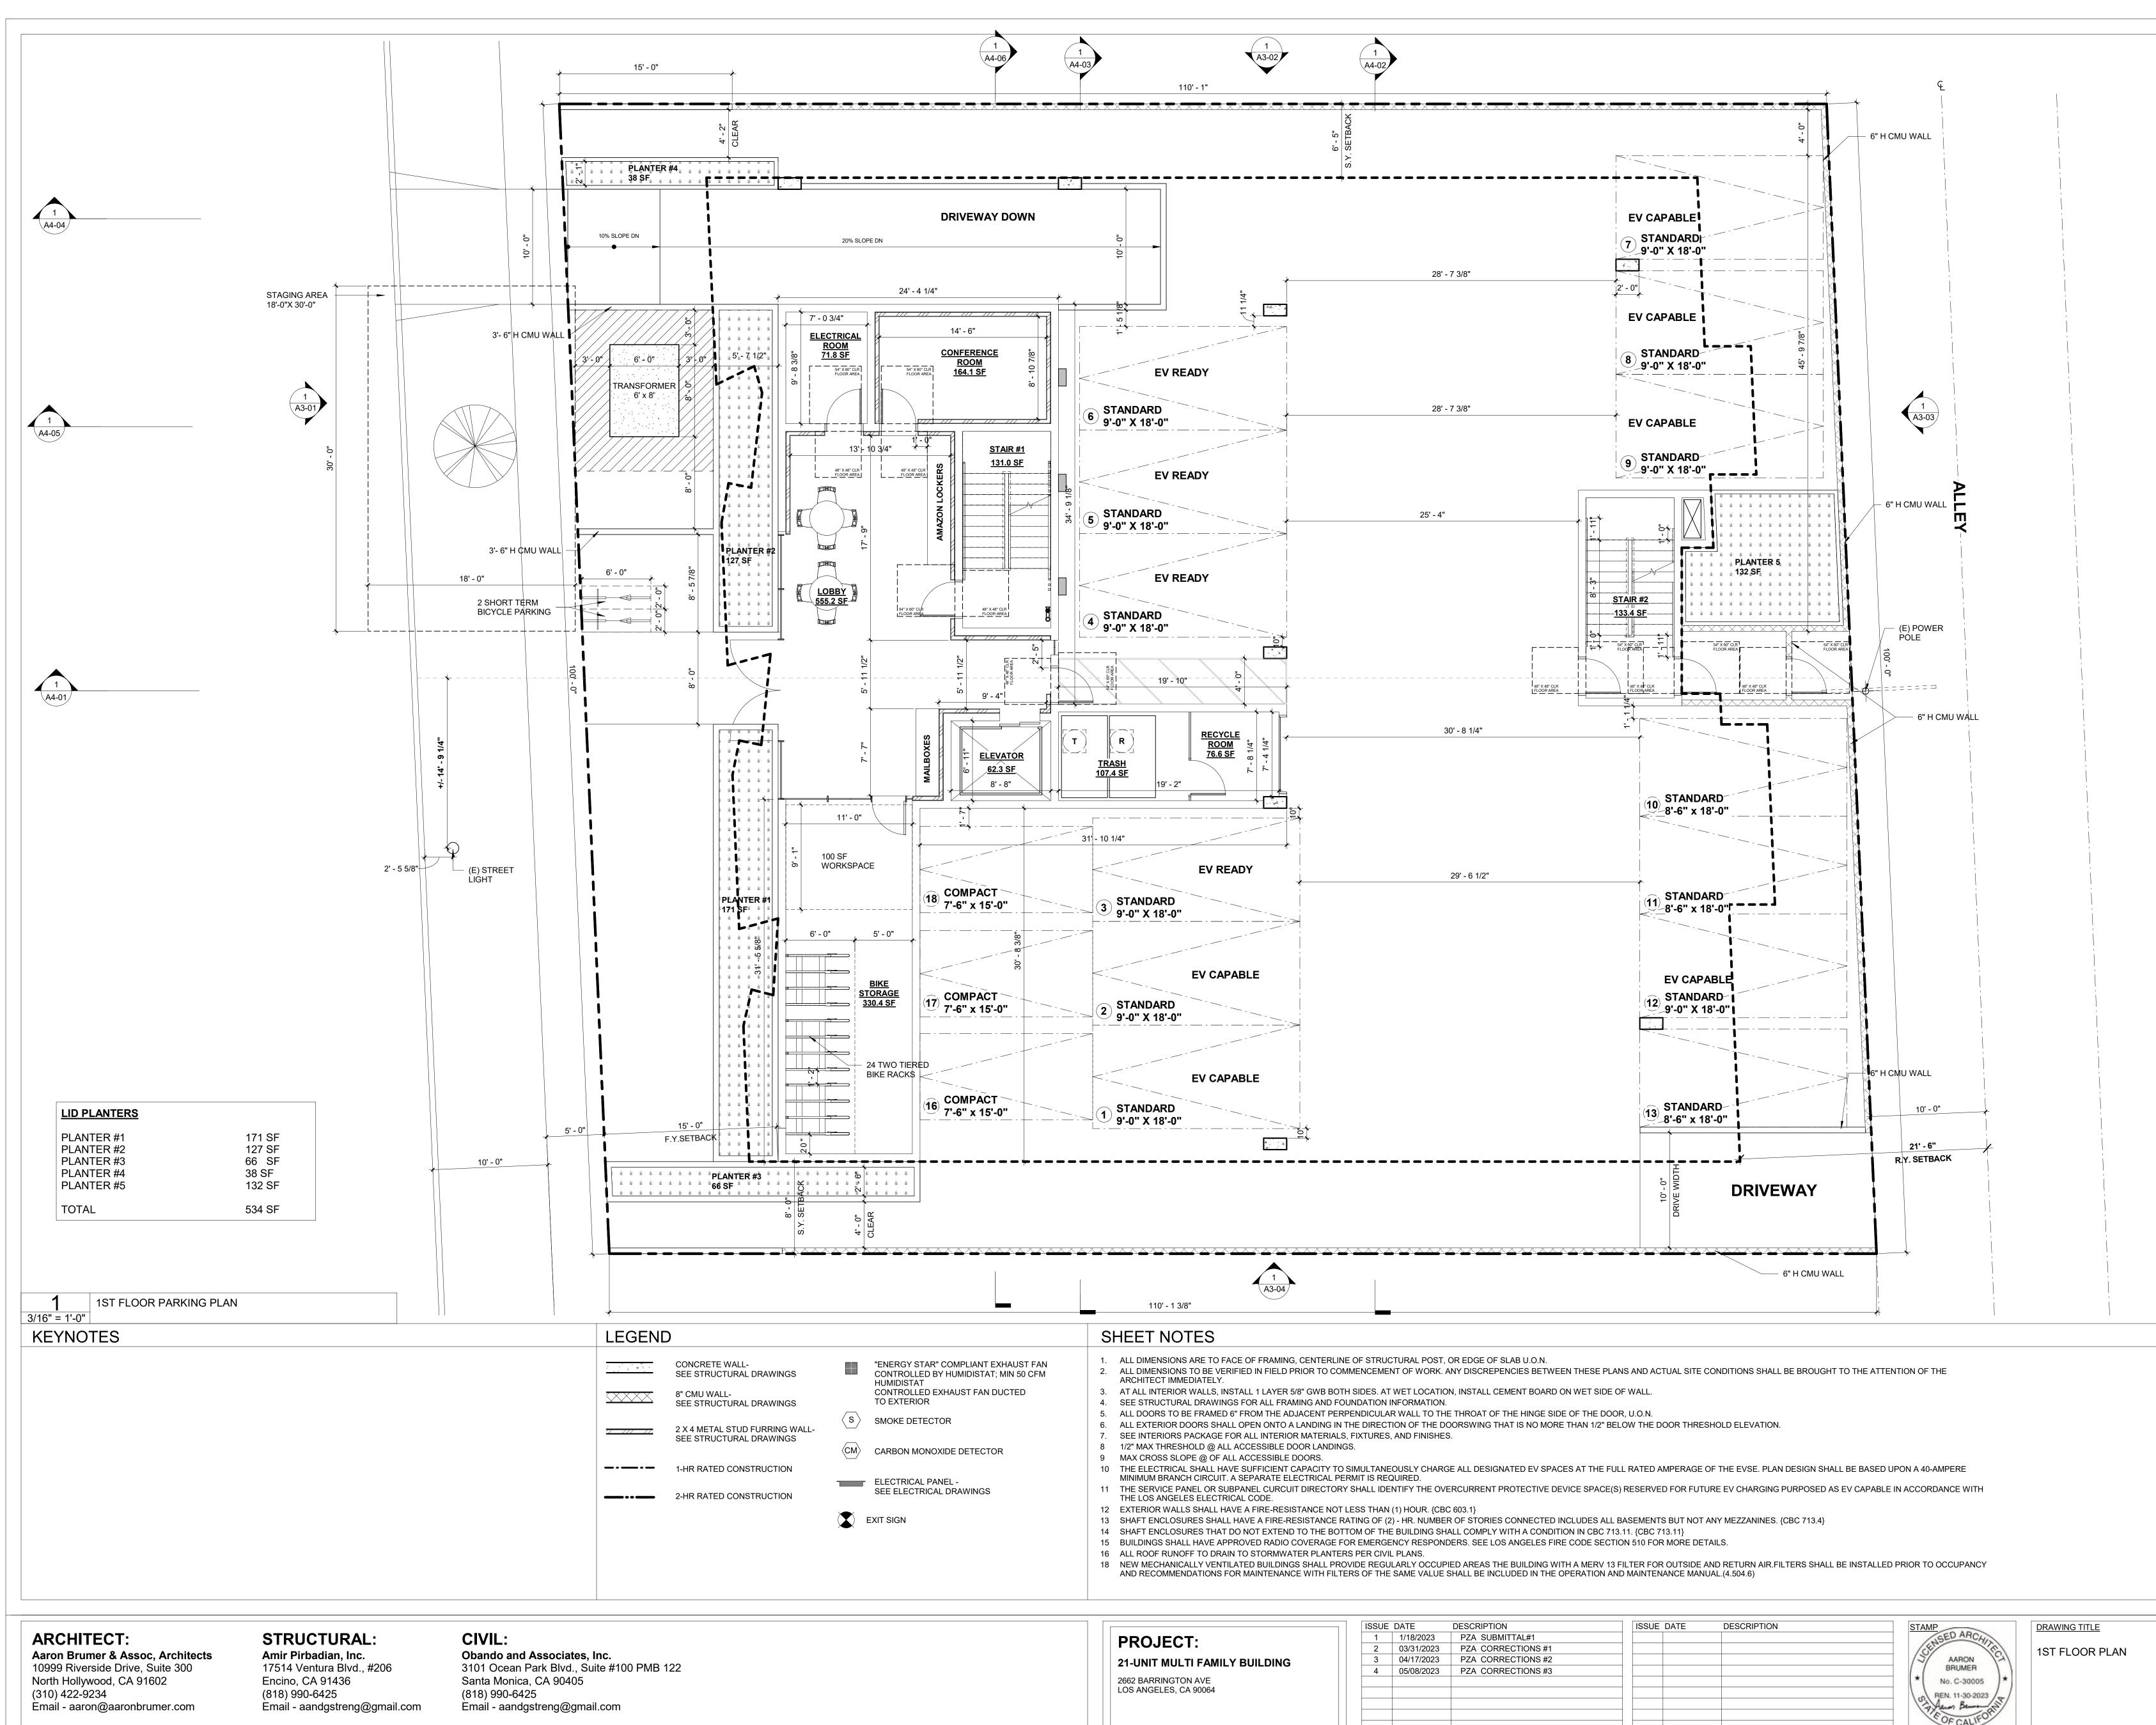

21-UNIT MULTI FAMILY BUIL
2662 BARRINGTON AVE LOS ANGELES, CA 90064


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PZA SUBMITTAL#1			13
PZA CORRECTIONS #1			18
PZA CORRECTIONS #2			15/
PZA CORRECTIONS #3			
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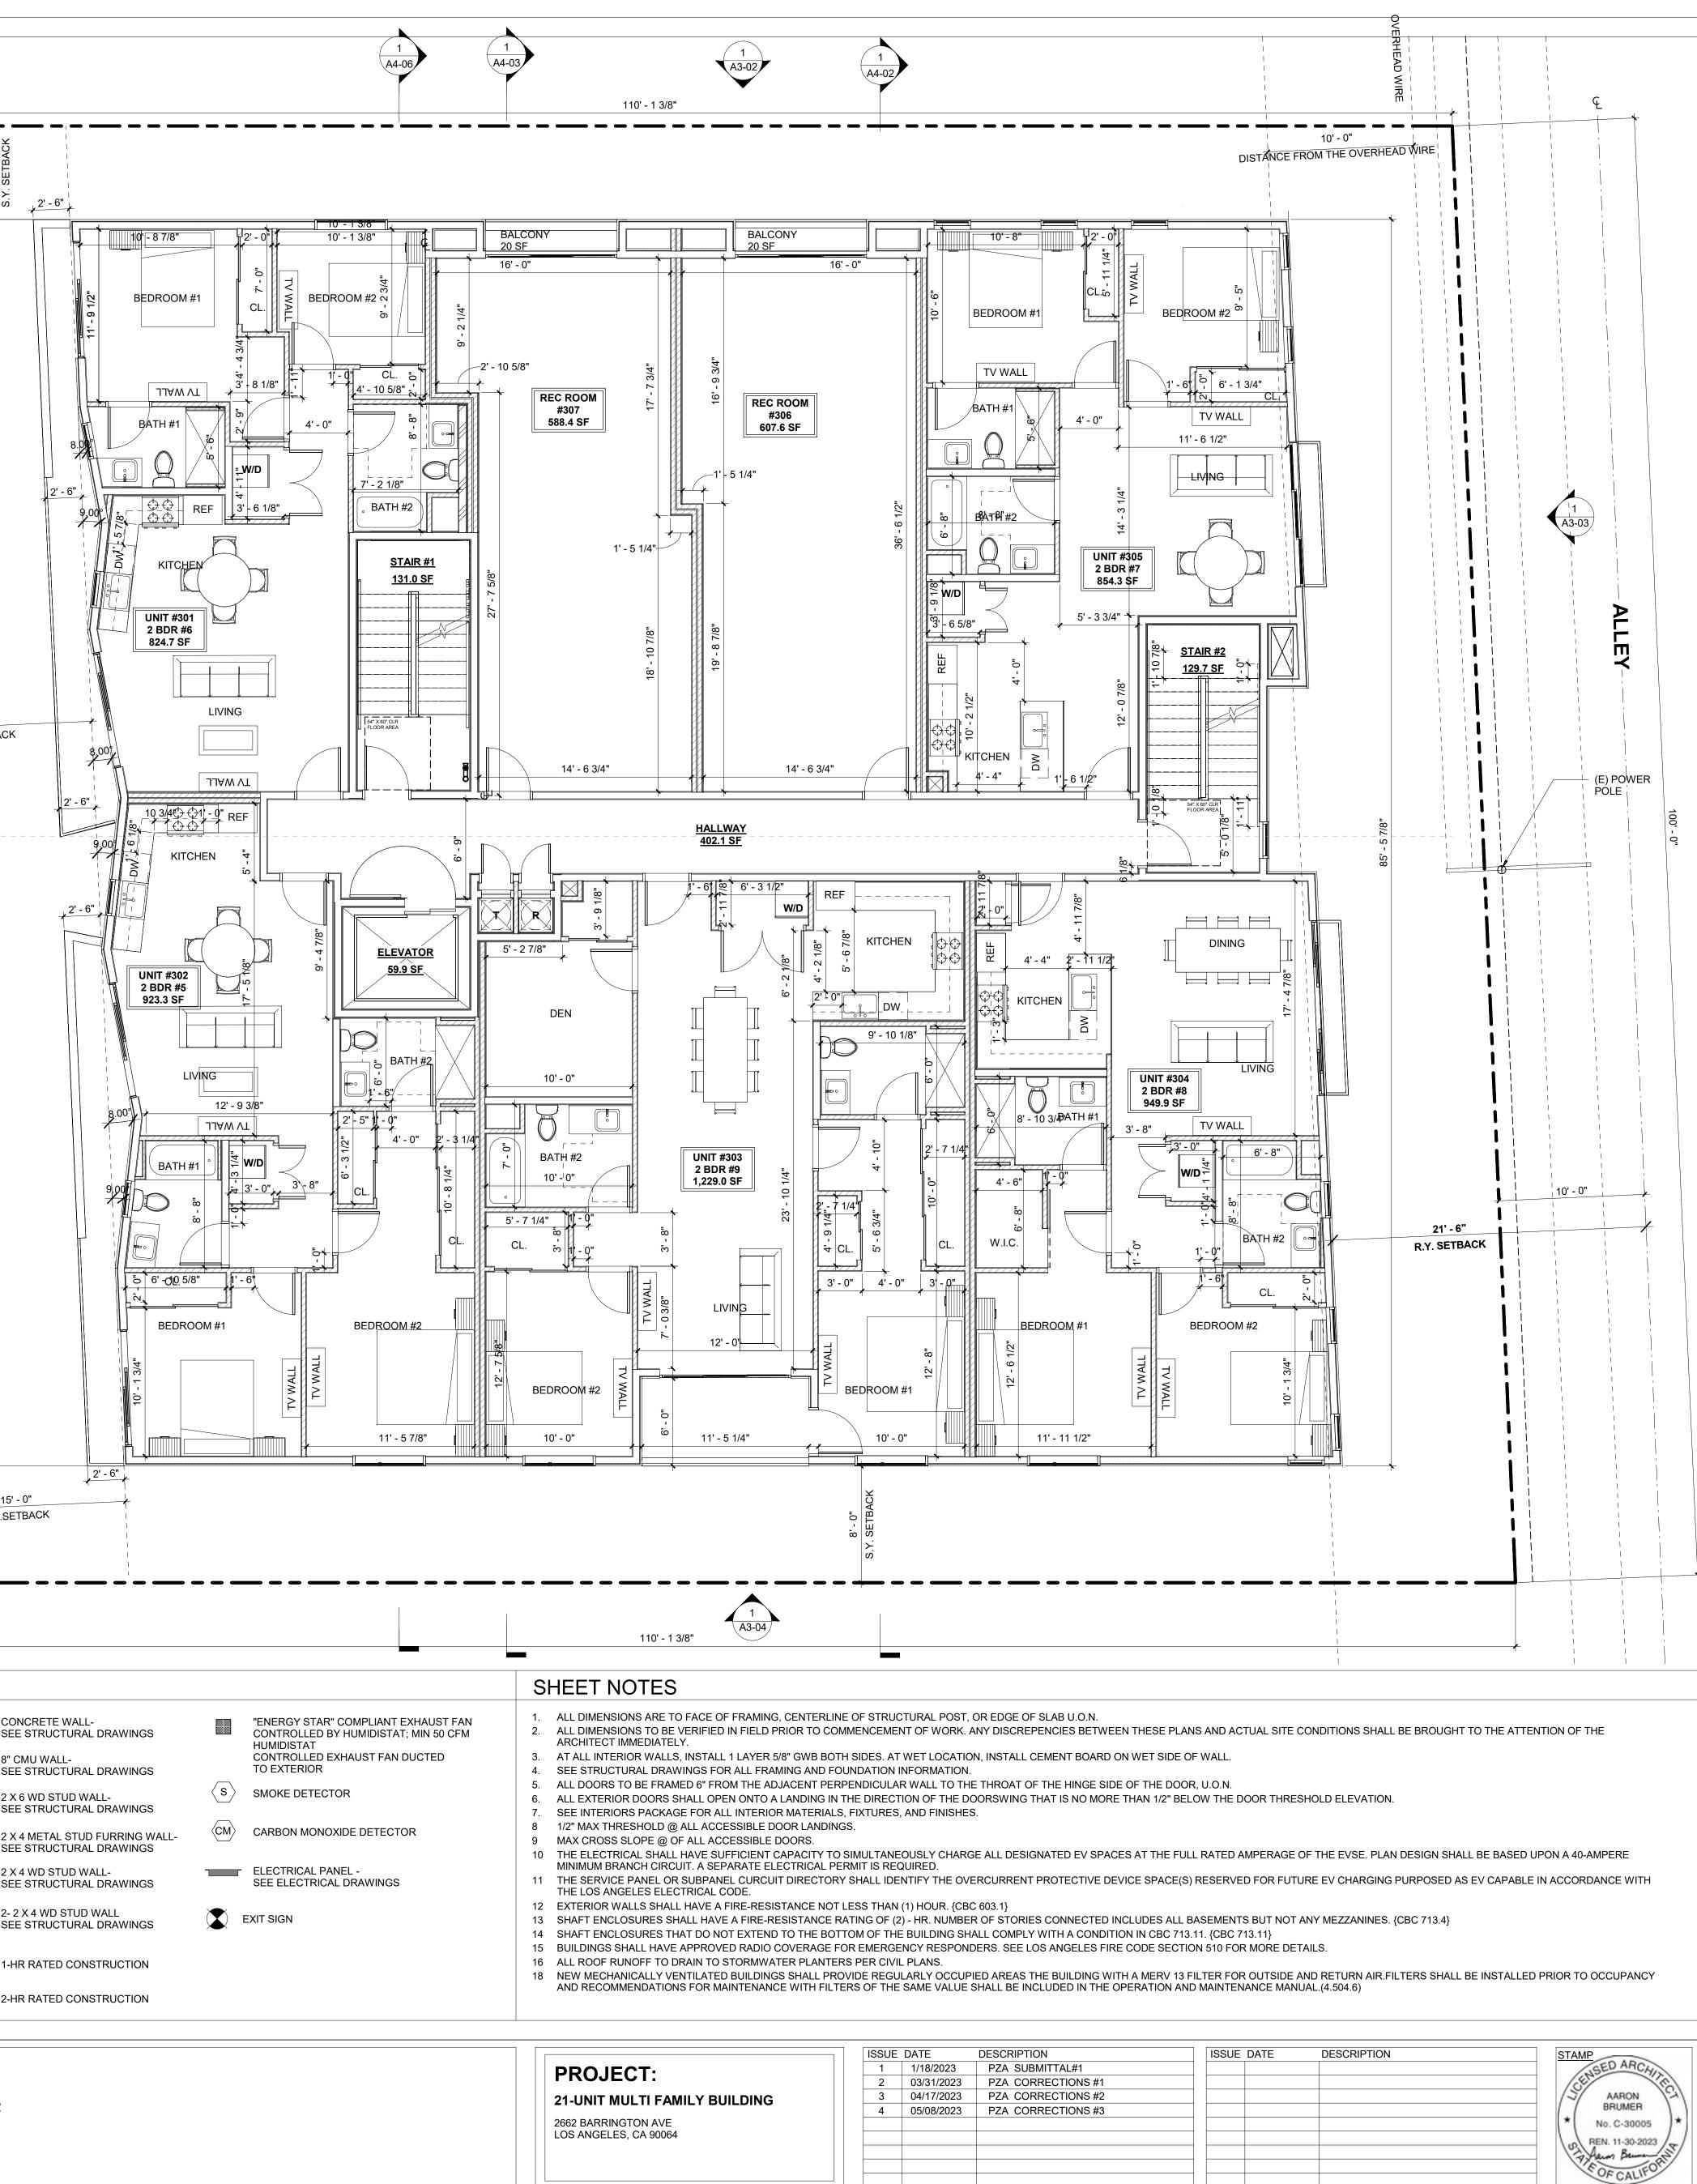

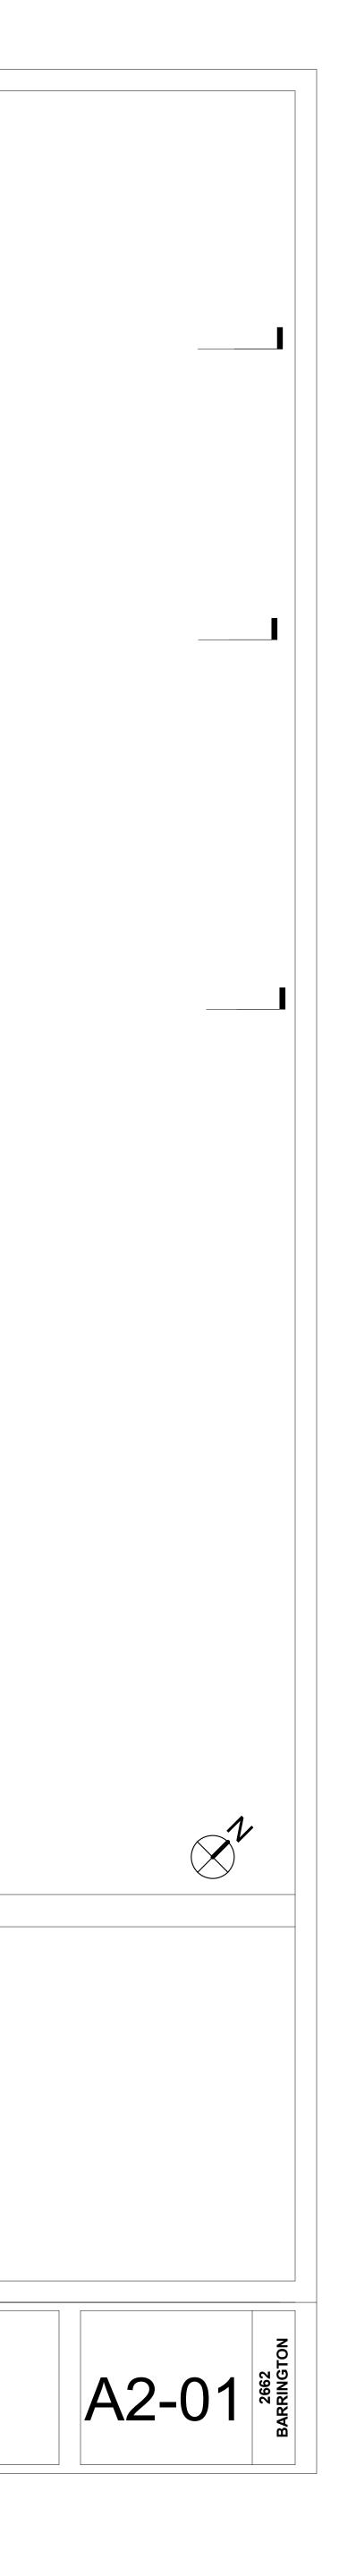
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		10
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	ISSUE DATE ISSUE ISSUE	ISSUE DATE DESCRIPTION

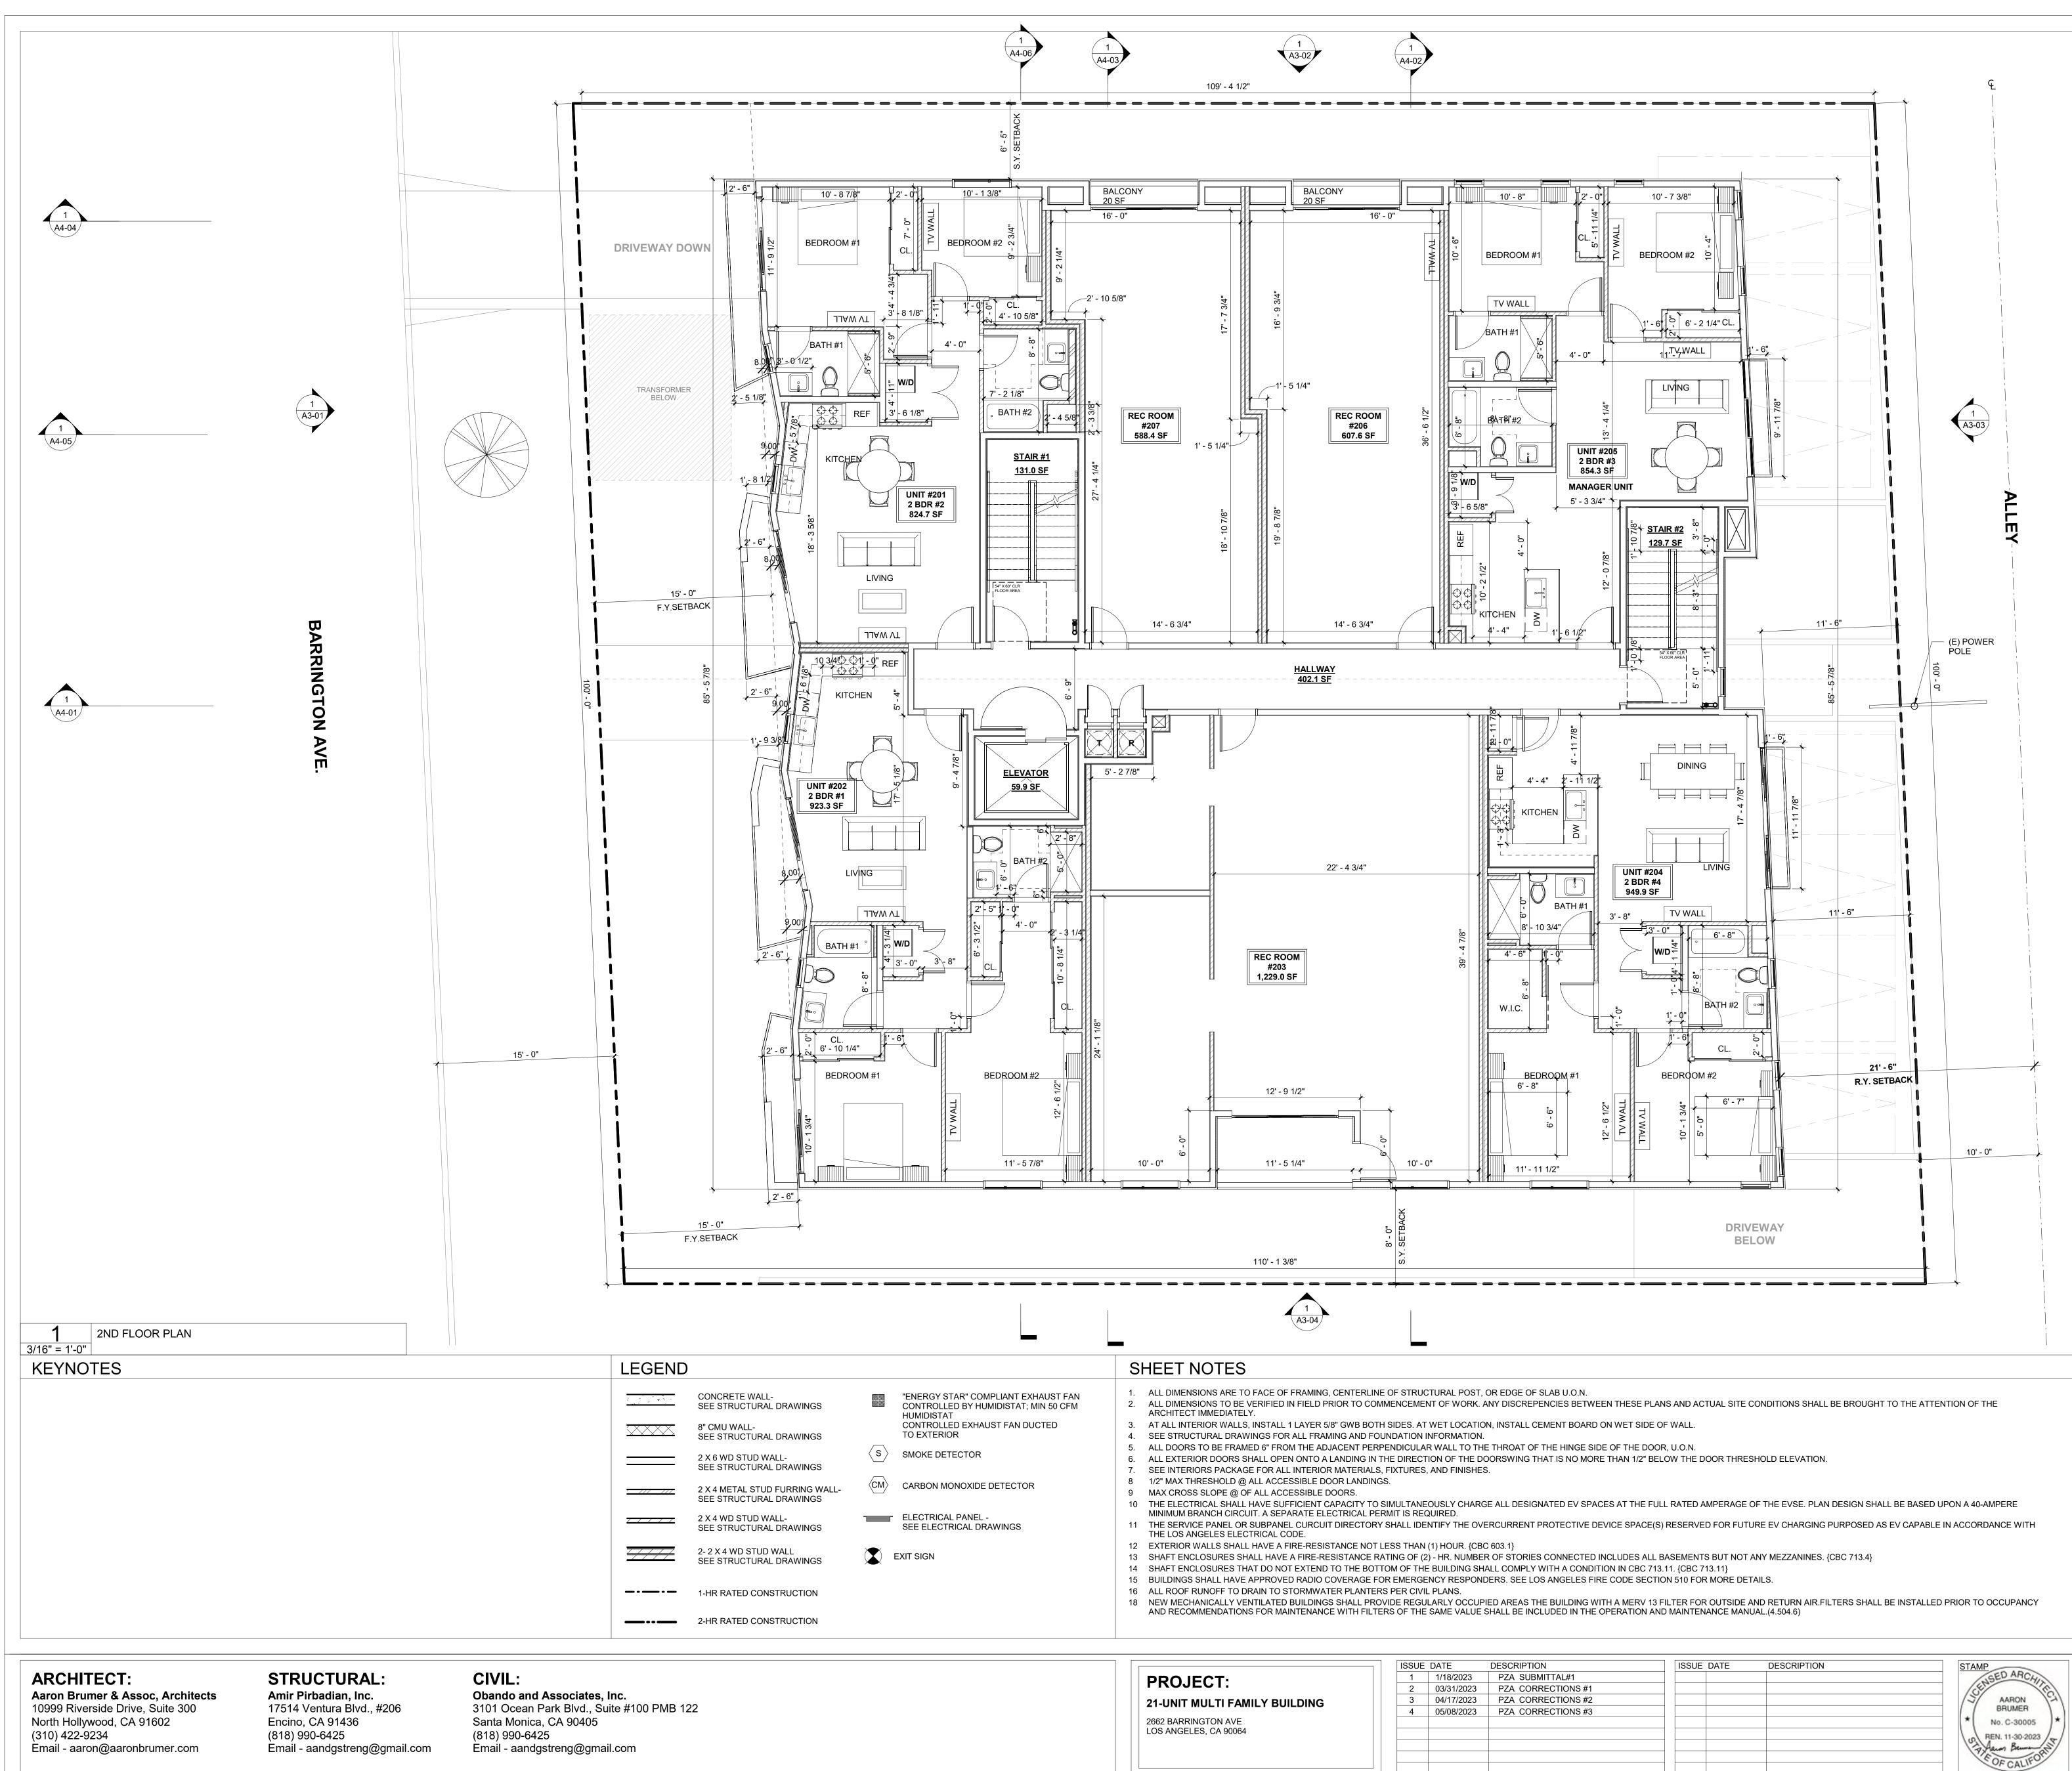DRAWING TITLE 2ND FLOOR PLAN




1 A4-05	
1 3/16" = 1'-0" XEYNOTES	

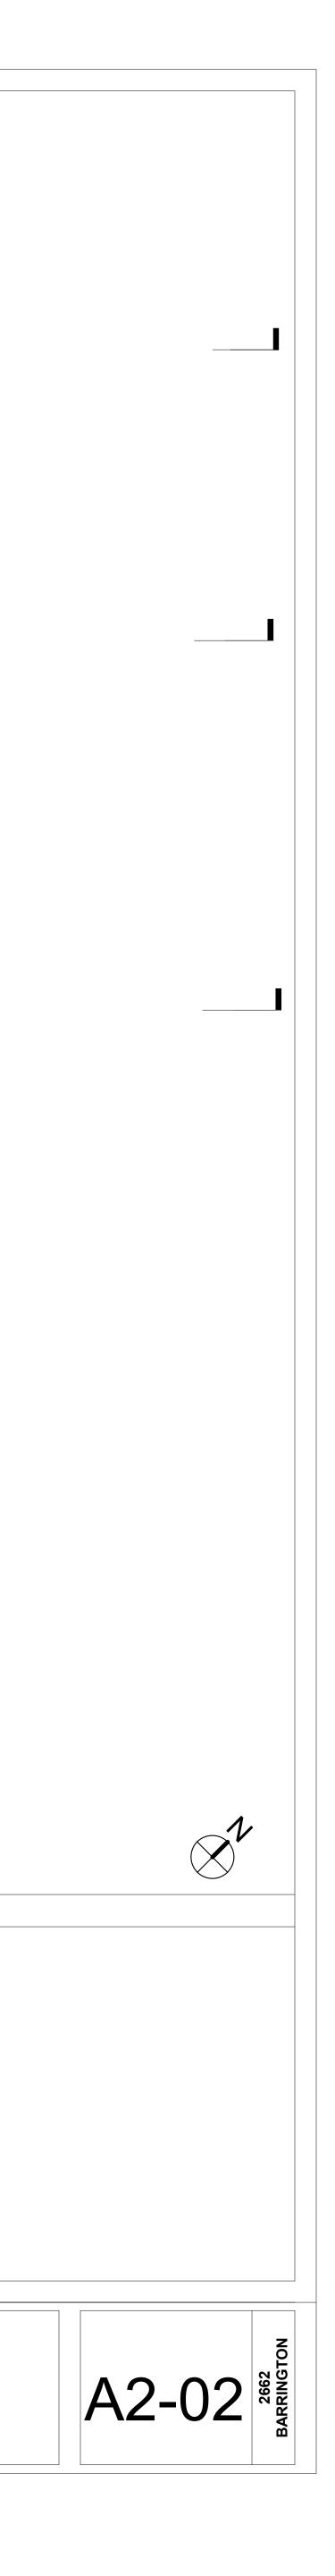


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		13
		*
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		1
	ISSUE DATE ISSUE DATE ISSUE ISSUE ISSUE ISSUE	ISSUE DATE DESCRIPTION

DRAWING TITLE 3RD FLOOR PLAN

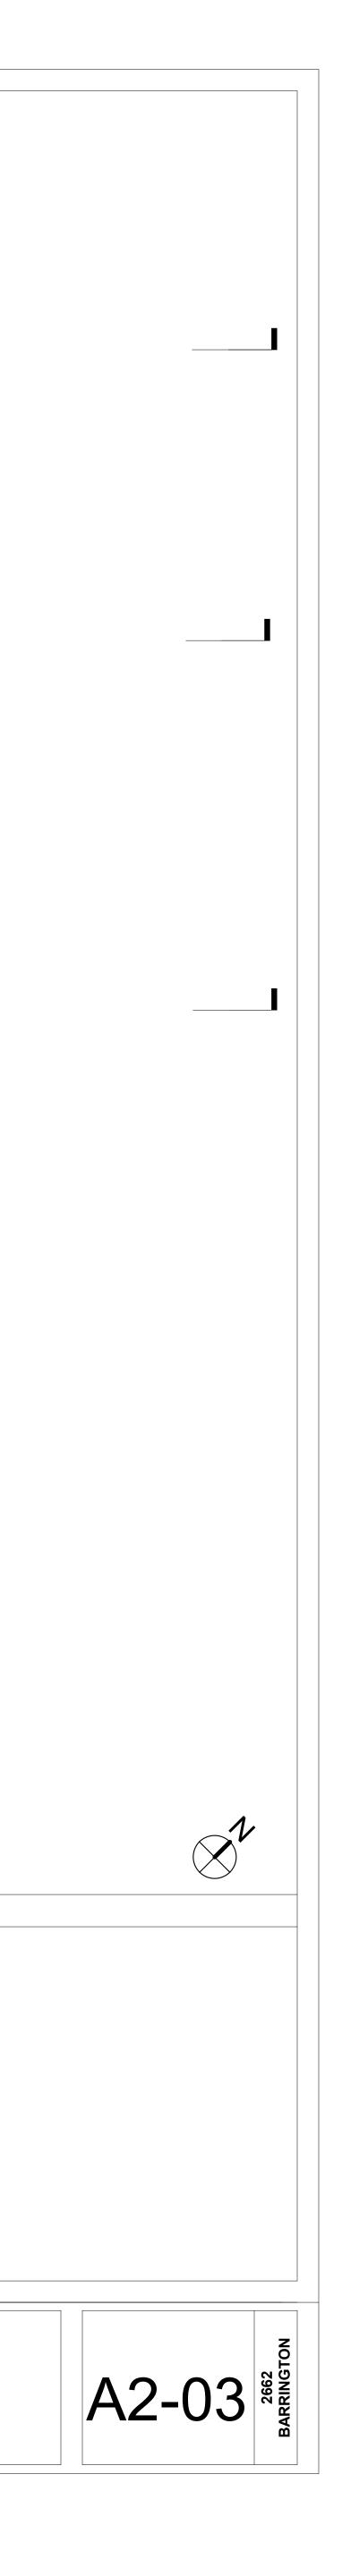


t t t t t t t t t t t t t t t t t t t	
1 A4-05	
	BARRINGTON AVE.
1 4TH FLOOR PLAN 3/16" = 1'-0"	
KEYNOTES	

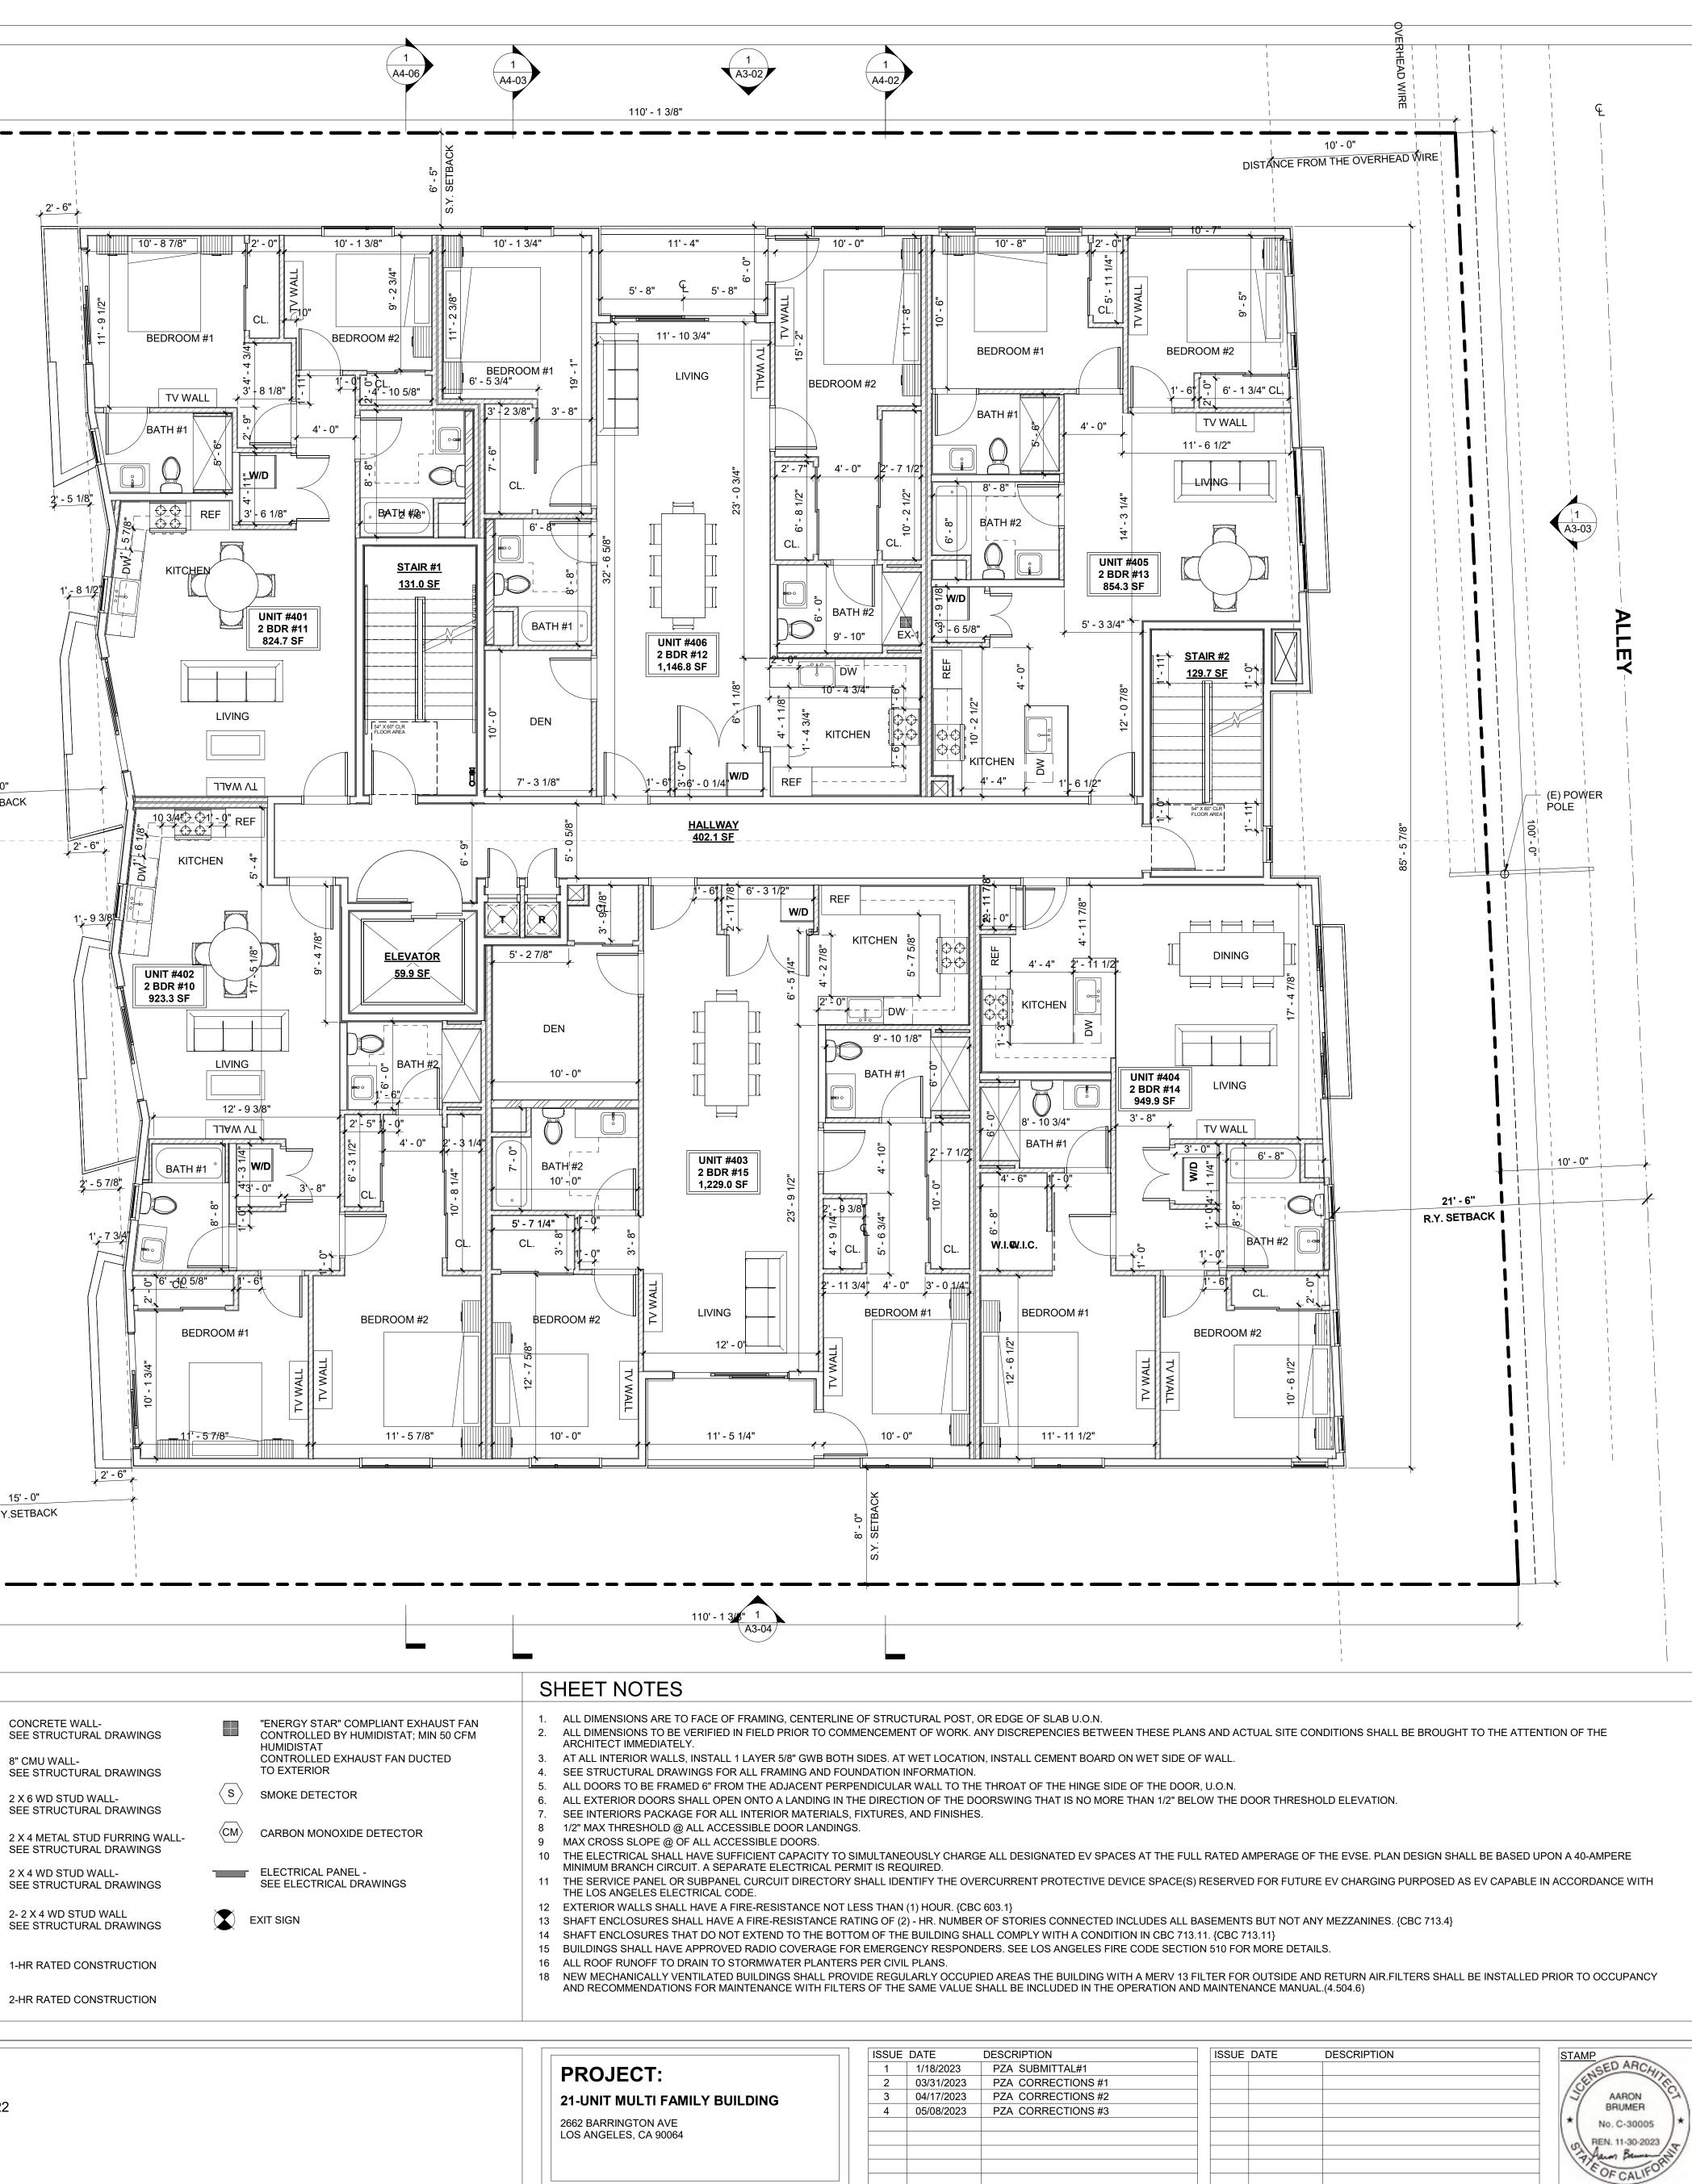


21-UNIT MULTI FAMILY BUILDIN
2662 BARRINGTON AVE LOS ANGELES, CA 90064

DESCRIPTION	ISSUE DATE	DESCRIPTION	
PZA SUBMITTAL#1			
PZA CORRECTIONS #1			
PZA CORRECTIONS #2			
PZA CORRECTIONS #3			

DRAWING TITLE 4TH FLOOR PLAN

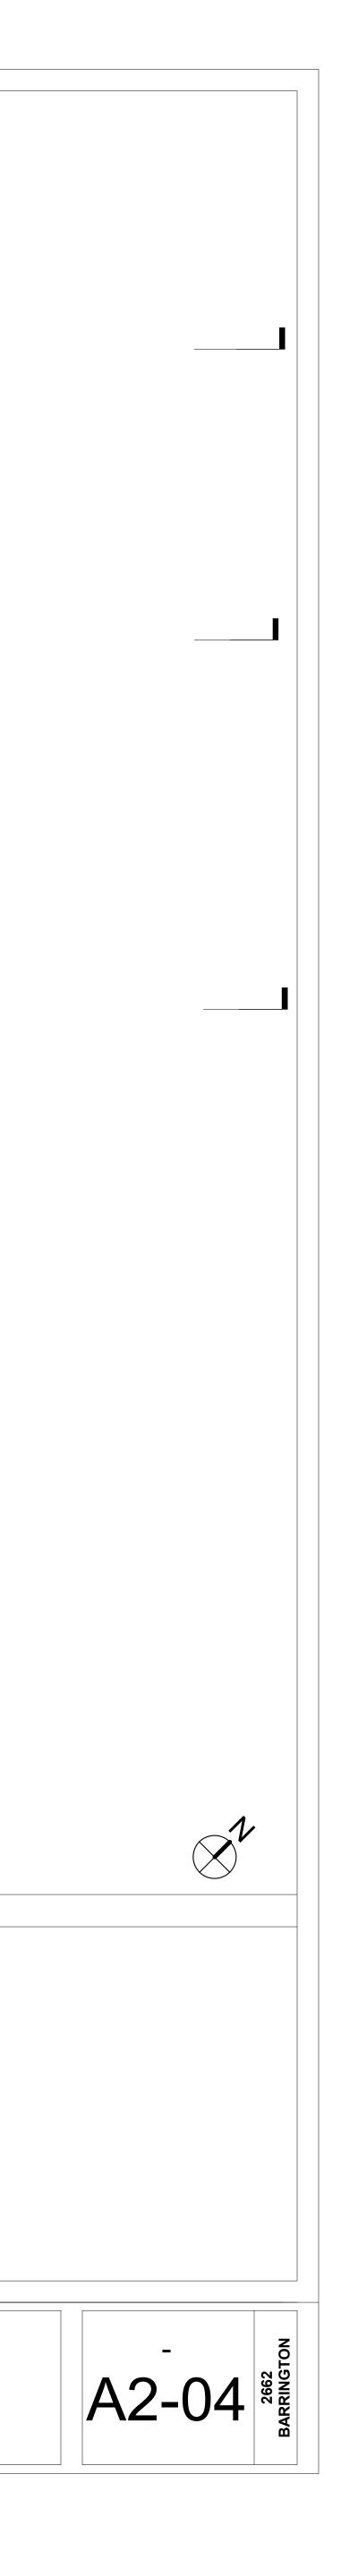


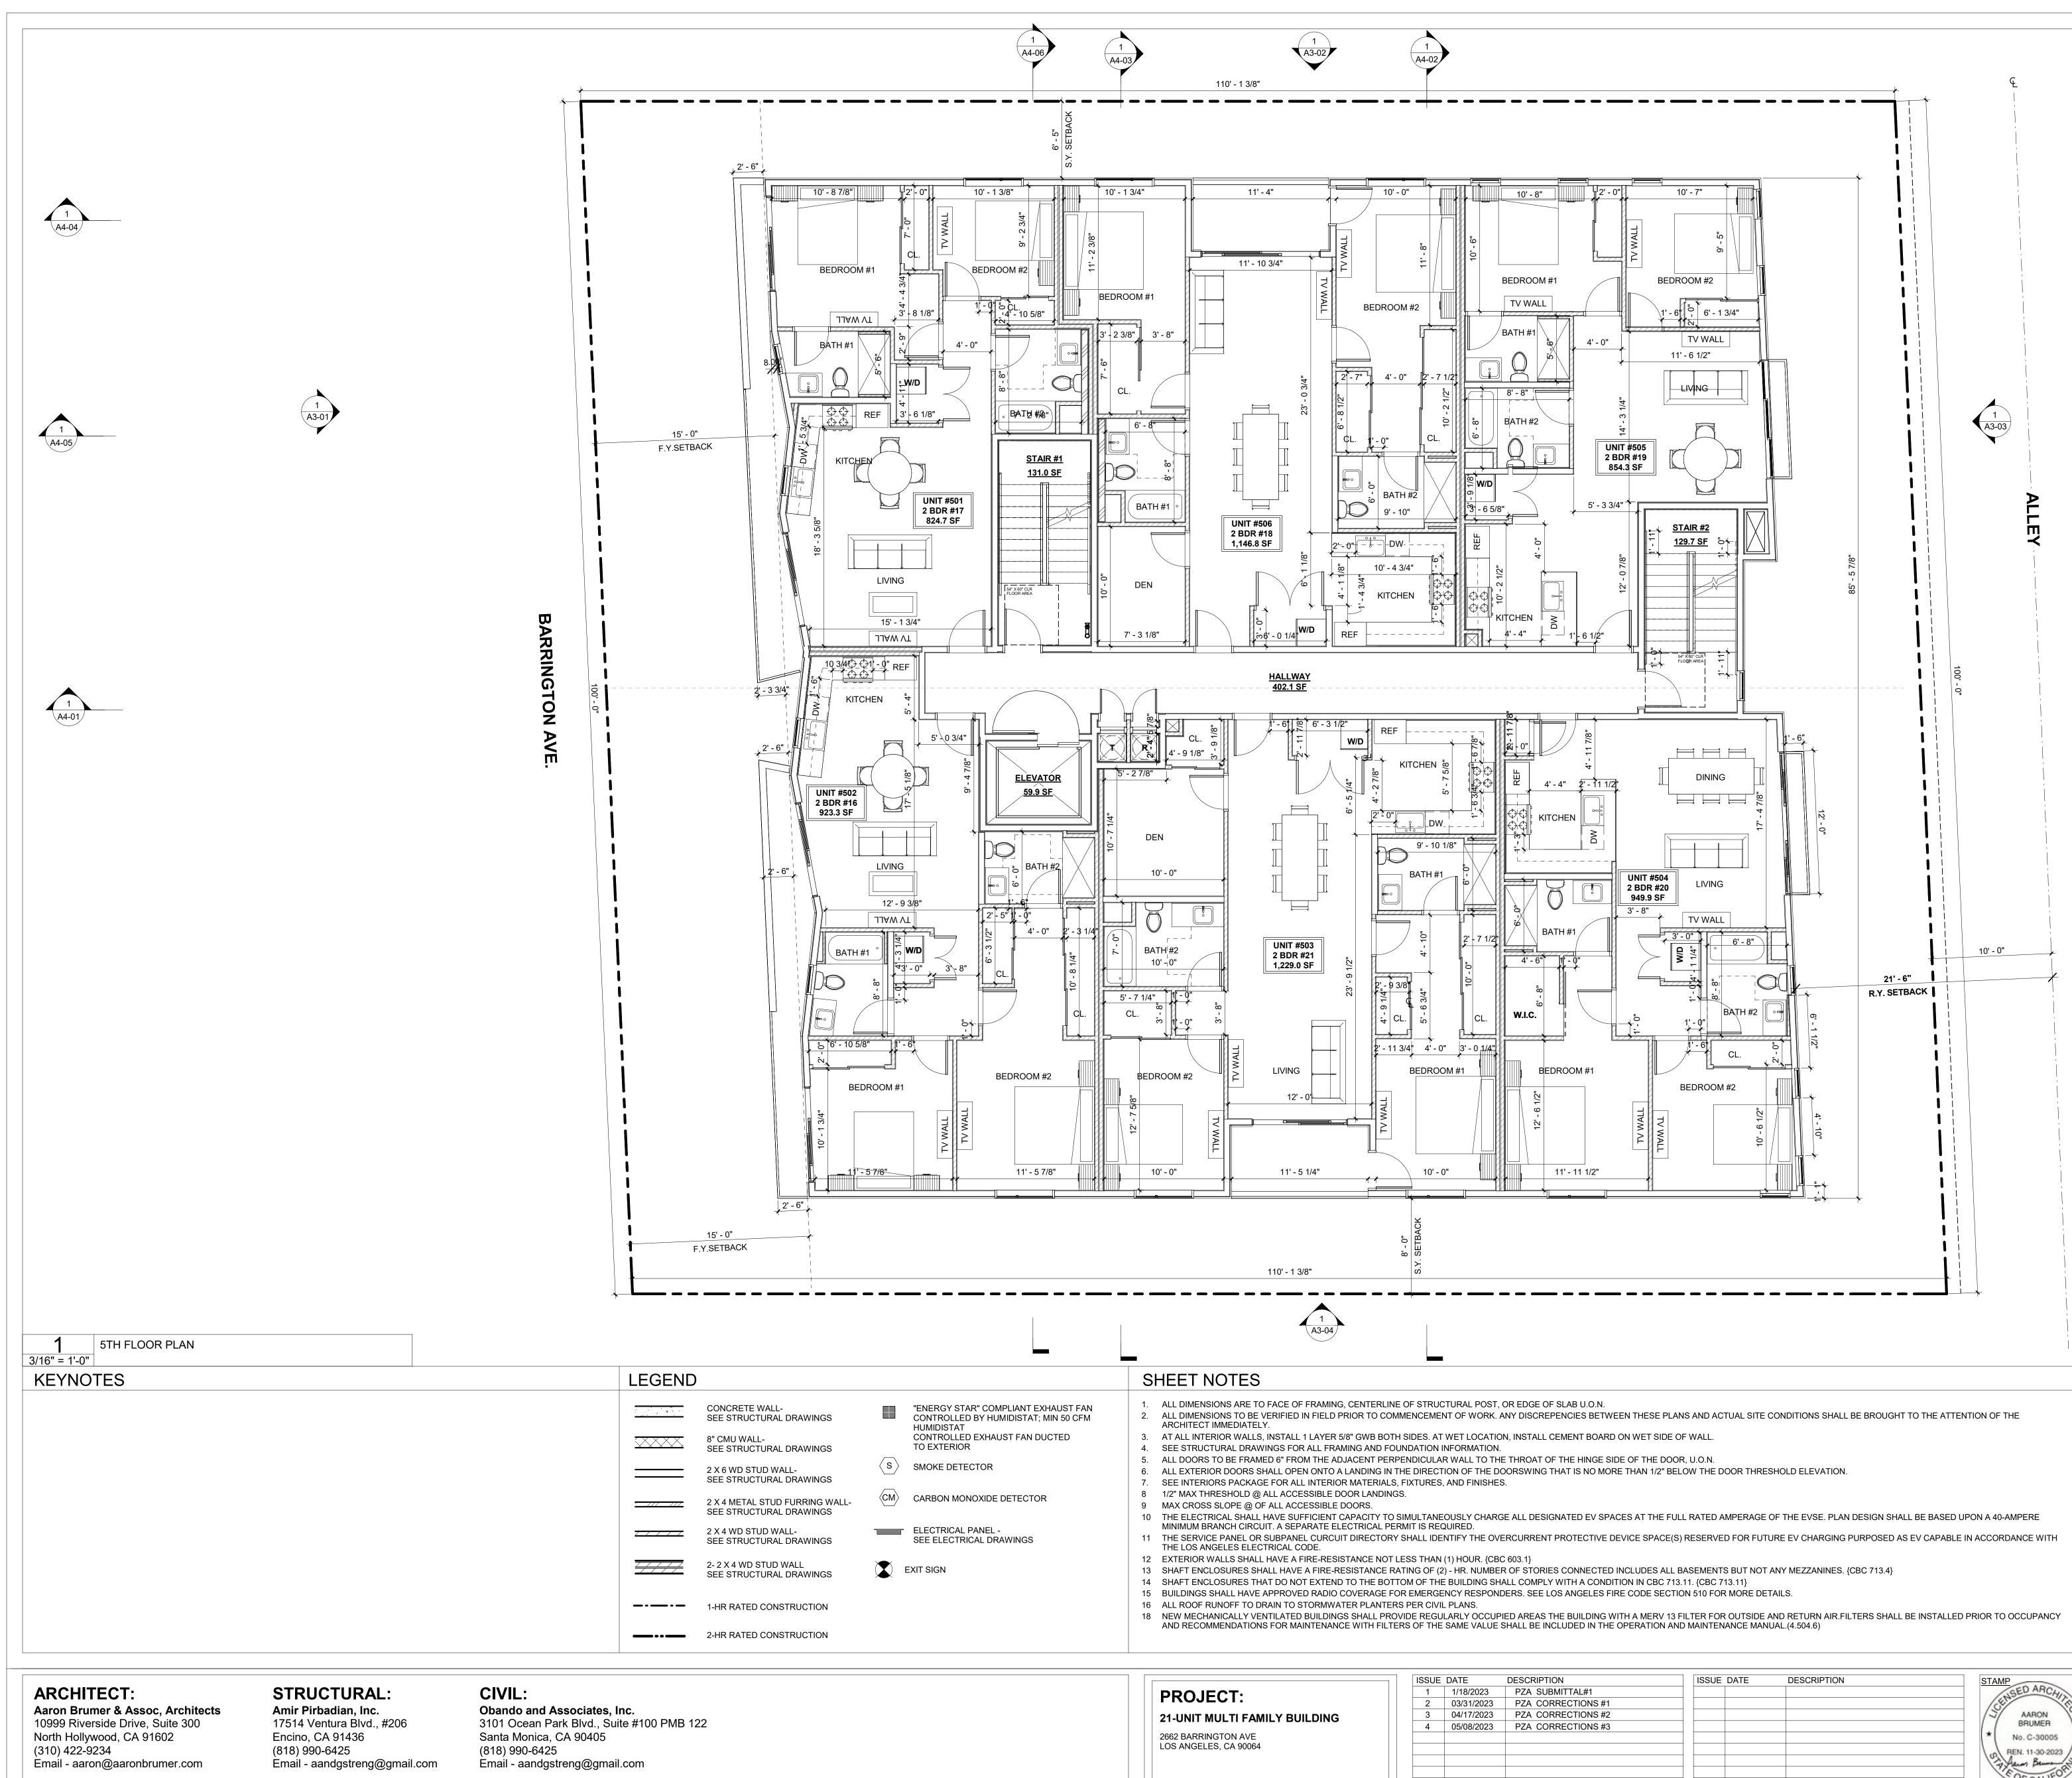


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PZA SUBMITTAL#1				
PZA CORRECTIONS #1				/
PZA CORRECTIONS #2				/-
PZA CORRECTIONS #3				
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AMP No. C-30005 REN. 11-30-2023 OFCAL

DRAWING TITLE 5TH FLOOR PLAN

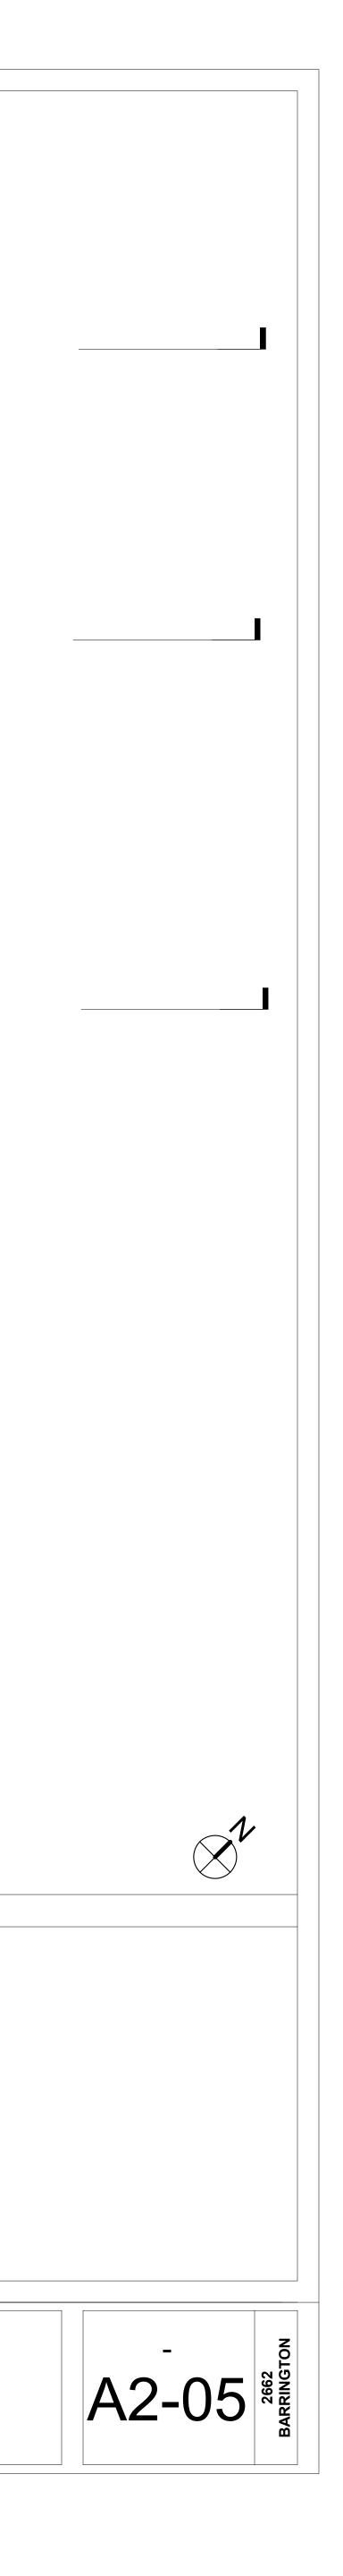


	A.	1 4-04		
		1 4-01	BARRINGTON AVE.	
1 6TH ROOF DECK PLAN 3/16" = 1'-0" 6TH ROOF DECK PLAN 3/16" = 1'-0" 0 KEYNOTES 01 DOWNSPOUT 02 THROUGH WALL SCUPPER. CONNECT TO DOWNSPOUT/GUTTER WHERE APPLICABLE 03 THROUGH WALL OVERFLOW SCUPPER 04 STANDPIPE 05 ELEVATOR FIRE DOOR 06 THROUGH WALL OPENING 07 HIDDEN LINE INDICATES FACE OF WALL BLW. 08 ROOFING TO BE CARLISLE SPECTRO-WELD WHITE TPO, ESR-1463, CLASS A INITIAL SOLAR REFLECTANCE AFTER 3 YEARS: 0.75 THERMAL EMITTANCE = 0.89 SRI: 111 9 SRI: 111	(0) HIDDEN LINE INDICATES PROPO ROOF DRAINAGE GUTTER SYST	SED ROUTE OF EM, TYP.		
SEE SHEET T-16 FOR SPECIFICATIONS ARCHITECT: Aaron Brumer & Assoc, Architects 10999 Riverside Drive, Suite 300 North Hollywood, CA 91602 (310) 422-9234	STRUCTURAL: Amir Pirbadian, Inc. 17514 Ventura Blvd., #206 Encino, CA 91436 (818) 990-6425	3101 Oc	and Assoc ean Park Bl onica, CA 9	lvd., Suite #100 PMB

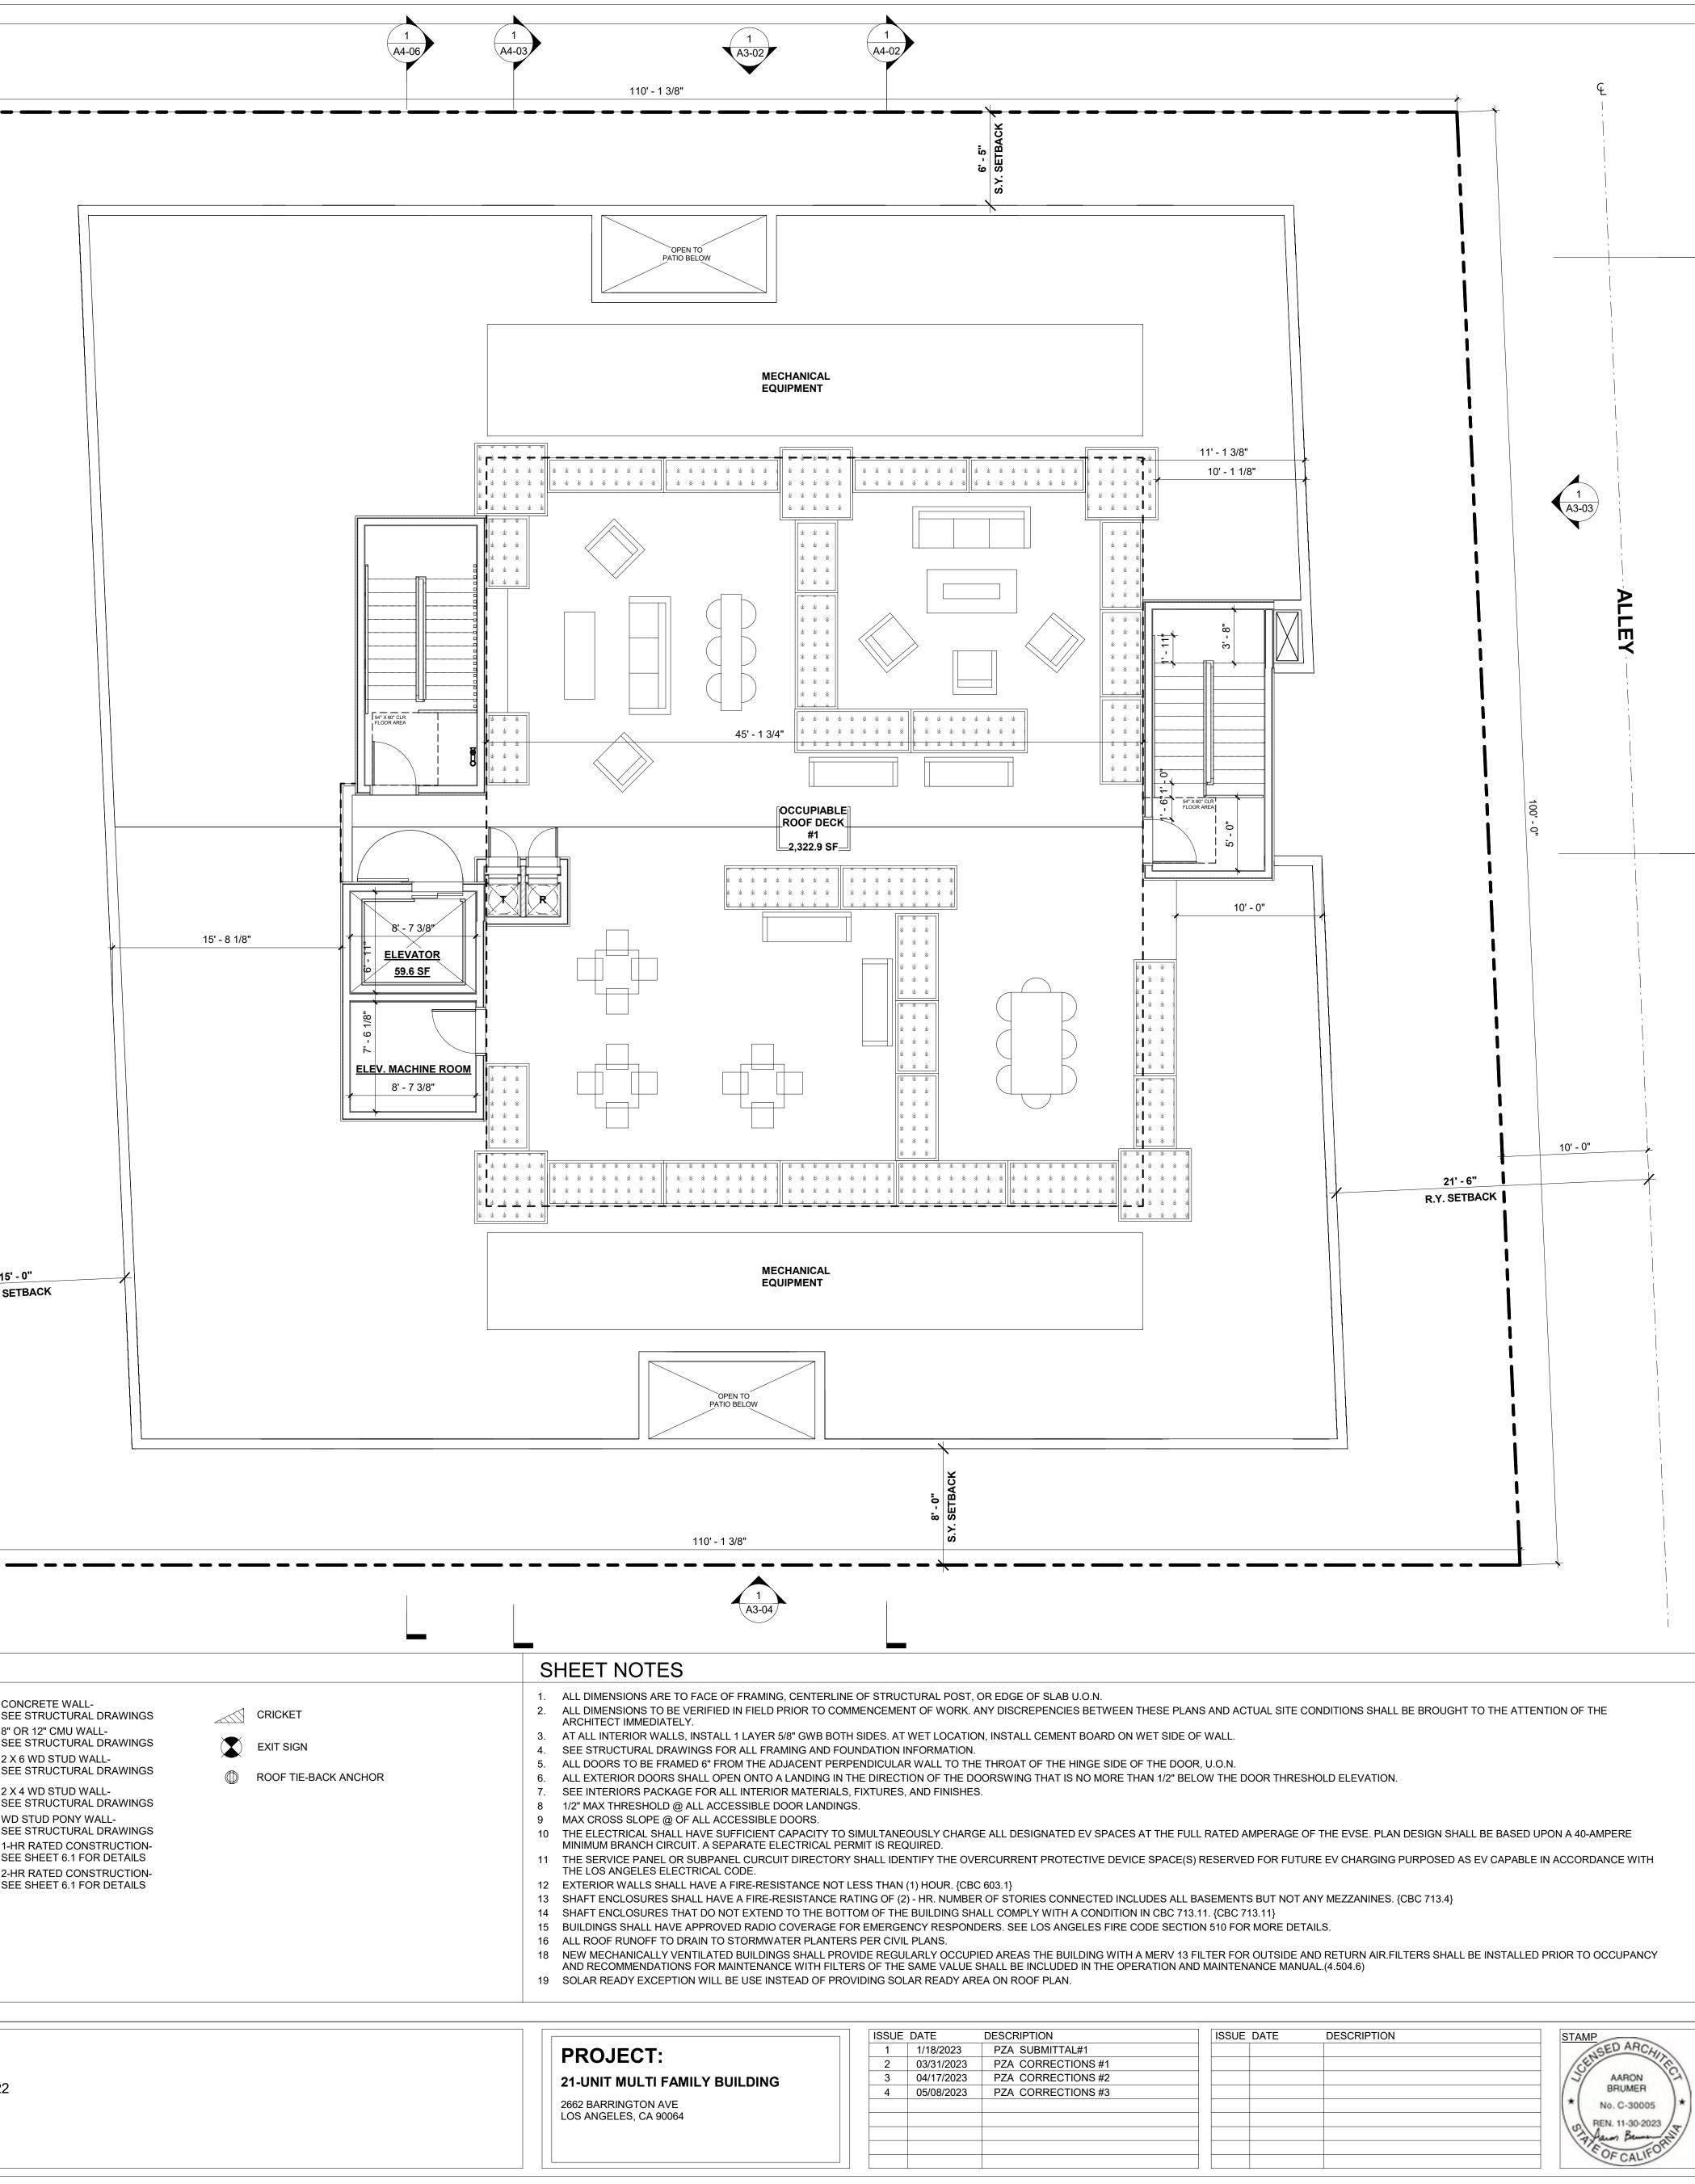


DESCRIPTION	ISSUE D	DATE	DESCRIPTION
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PZA CORRECTIONS #1			
PZA CORRECTIONS #2			
PZA CORRECTIONS #3			

DRAWING TITLE ROOF DECK PLAN

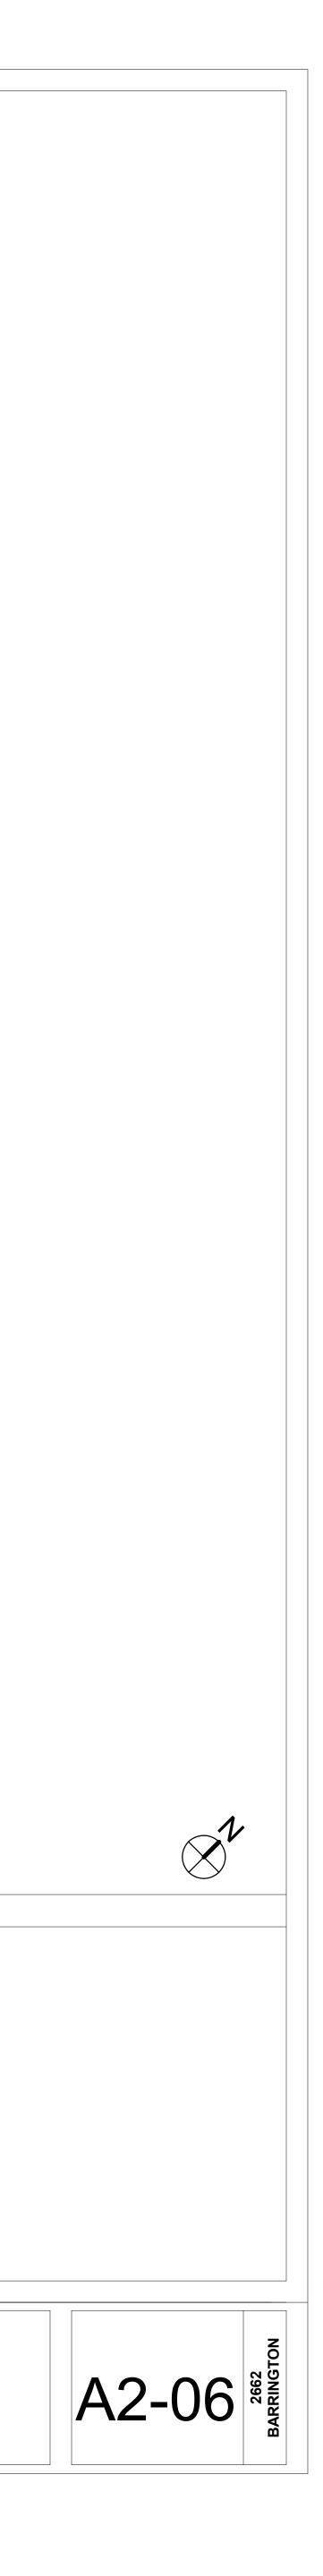

 06 THROUGH WALL OPENING 07 HIDDEN LINE INDICATES FACE OF WALL BLW. 08 ROOFING TO BE CARLISLE SPECTRO-WELD WHITE TPO, ESR-1463, CLASS A INITIAL SOLAR REFLECTANCE: 0.88 SOLAR REFLECTANCE AFTER 3 YEARS: 0.75 THERMAL EMITTANCE = 0.89 SRI: 111 SEE SHEET T-16 FOR SPECIFICATIONS 			
 03 THROUGH WALL OVERFLOW SCUPPER 04 STANDPIPE 05 ELEVATOR FIRE DOOR 			
01 DOWNSPOUT 02 THROUGH WALL SCUPPER. CONNECT TO DOWNSPOUT/GUTTER WHERE APPLICABLE	(09) HIDDEN LINE INDICATES PROPOSED ROOF DRAINAGE GUTTER SYSTEM,) ROUTE OF TYP.	
/16" = 1'-0" KEYNOTES			LEGEN
1 6TH ROOF DRAINAGE PLAN			
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A4-05	r		
	1 A3-01		
1 A4-04			
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DRAWING TITLE ROOF DRAINAGE PLAN

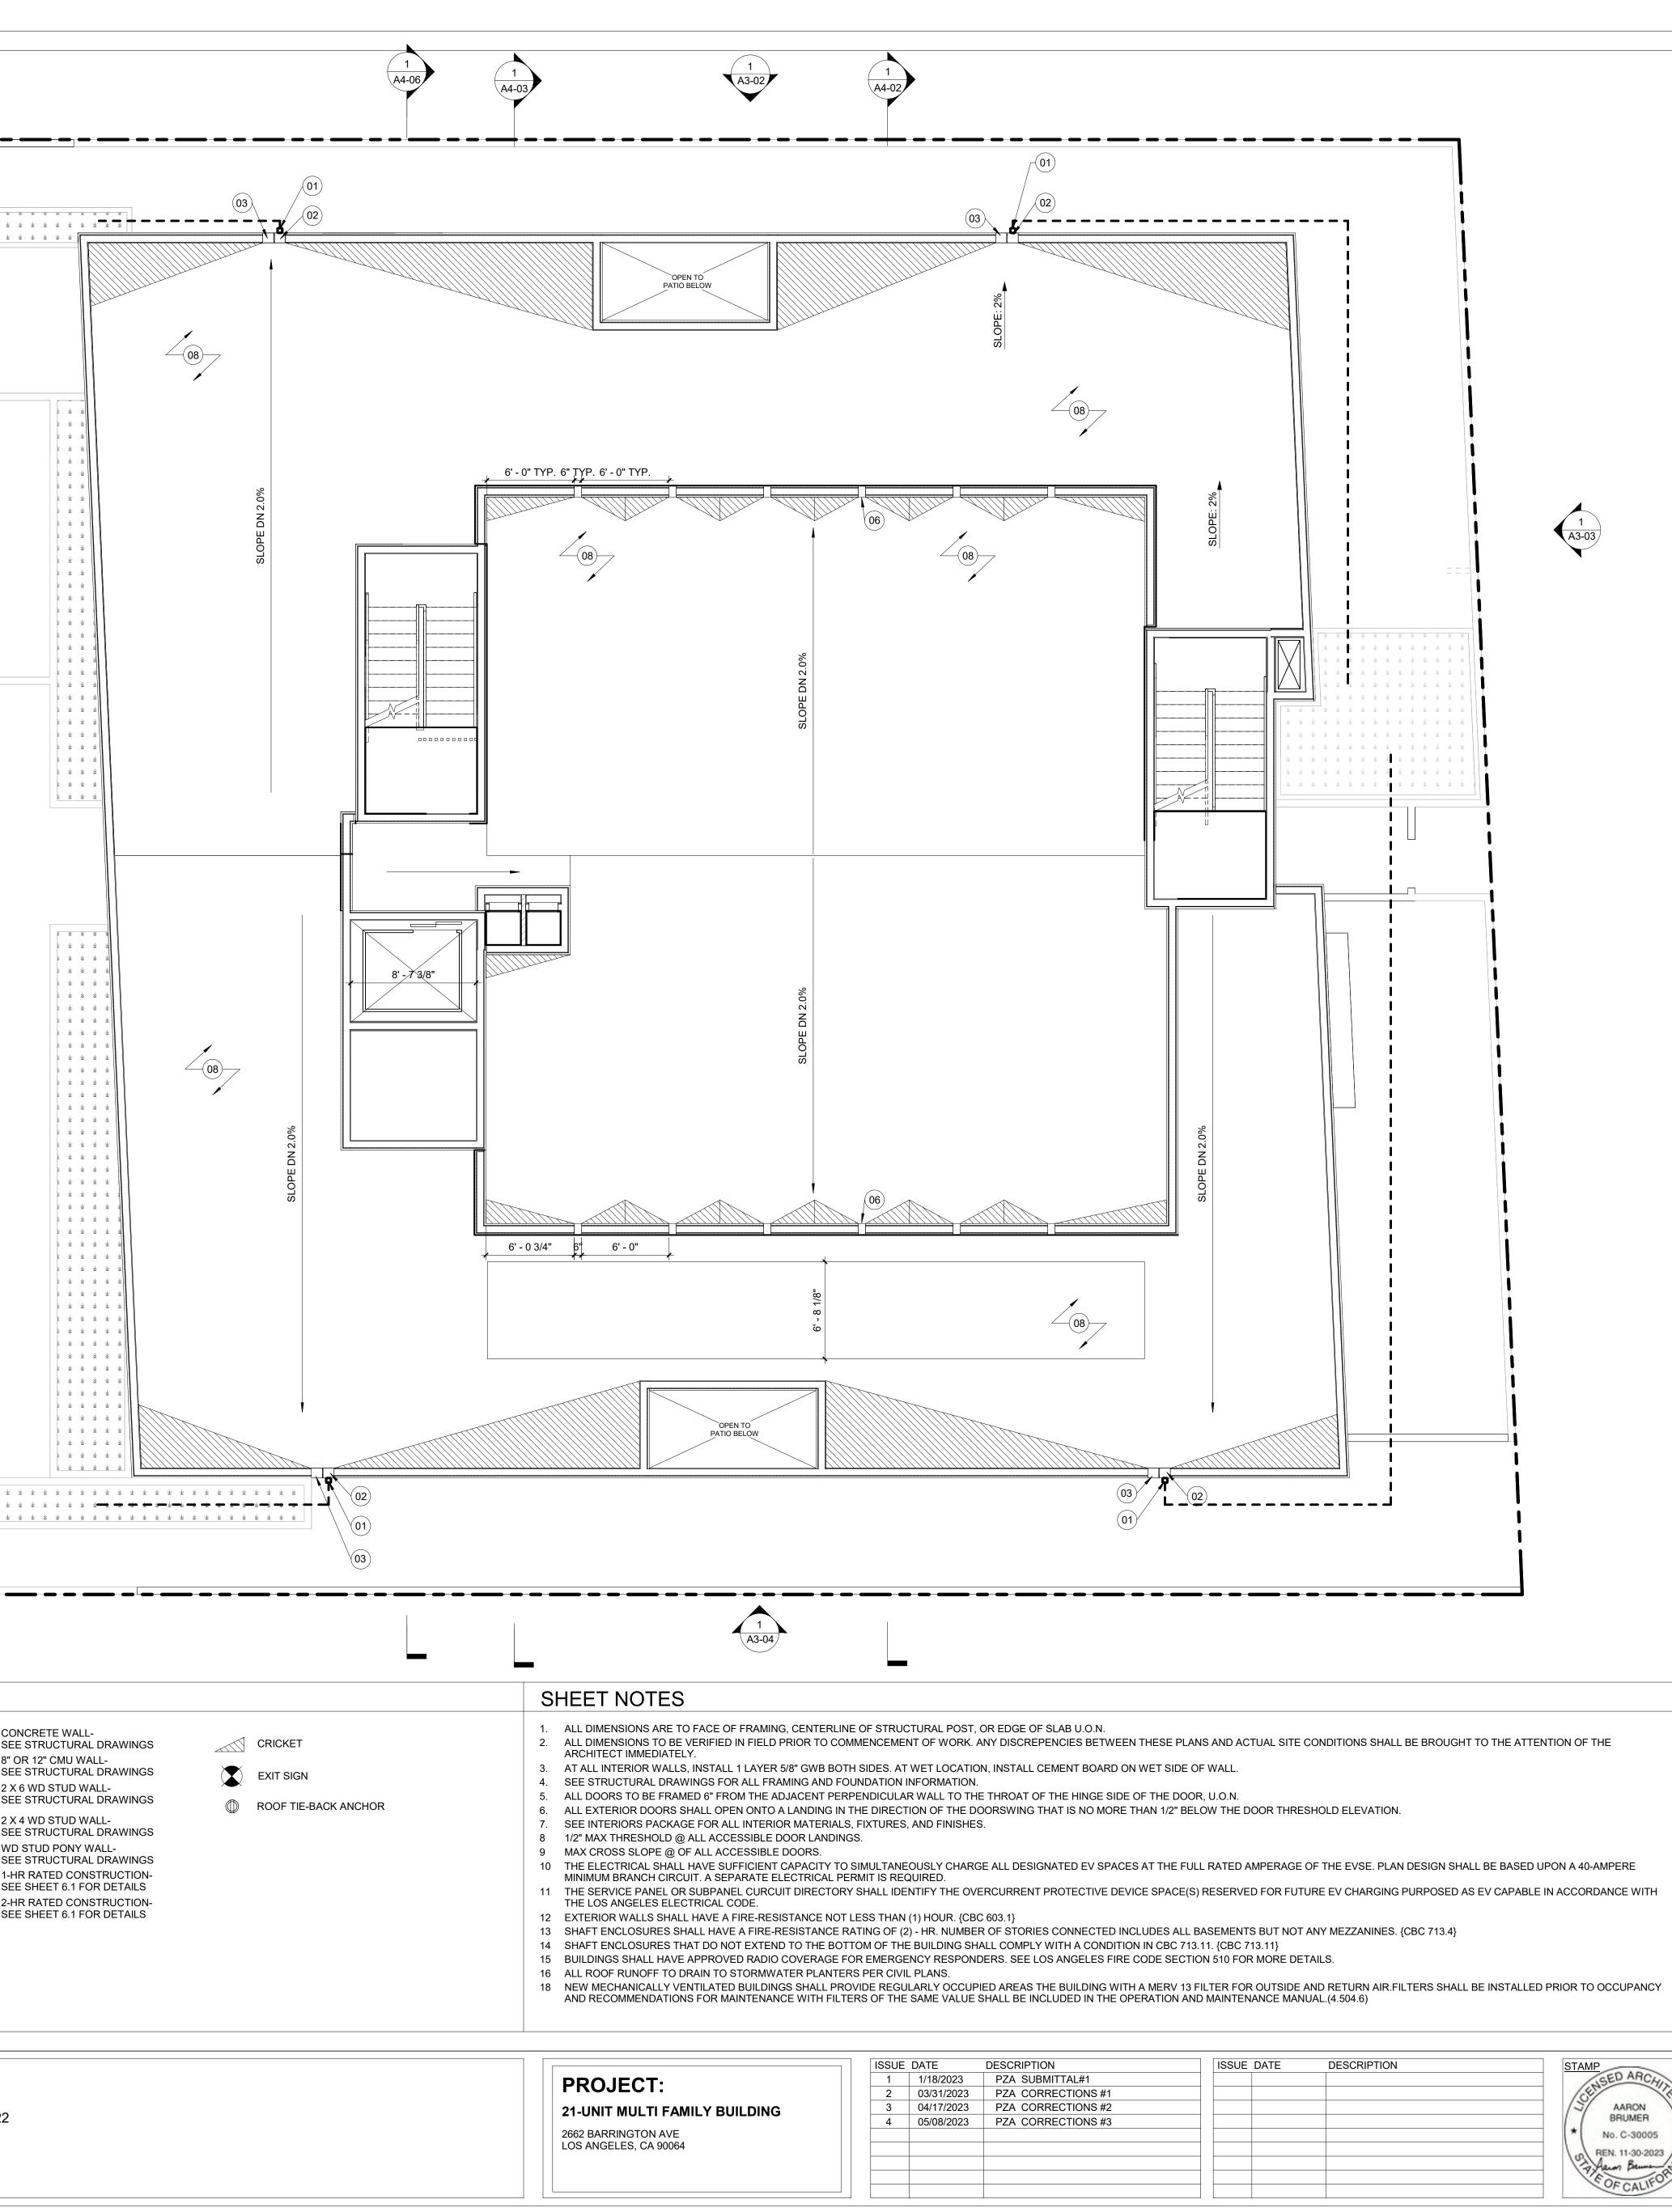
SED ARCA

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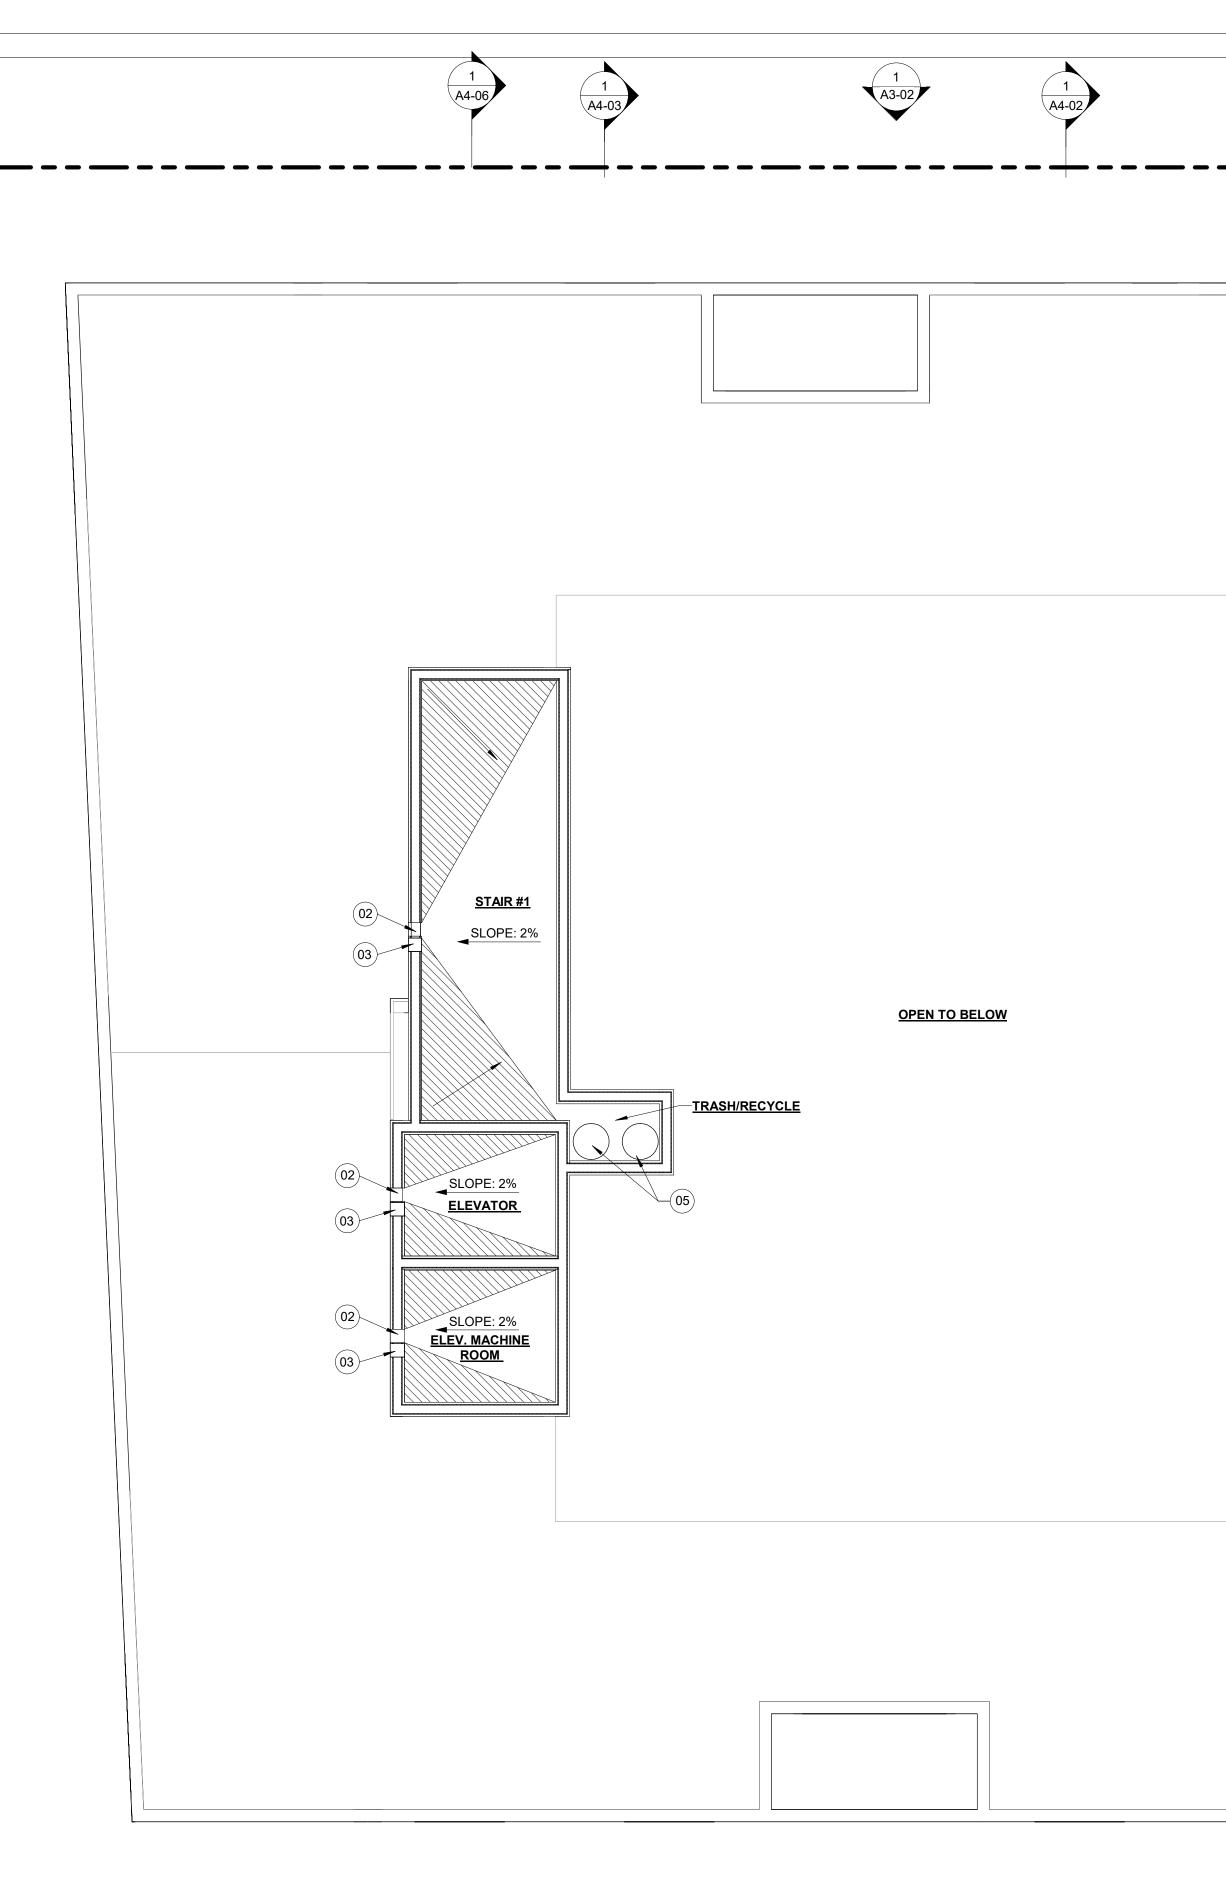
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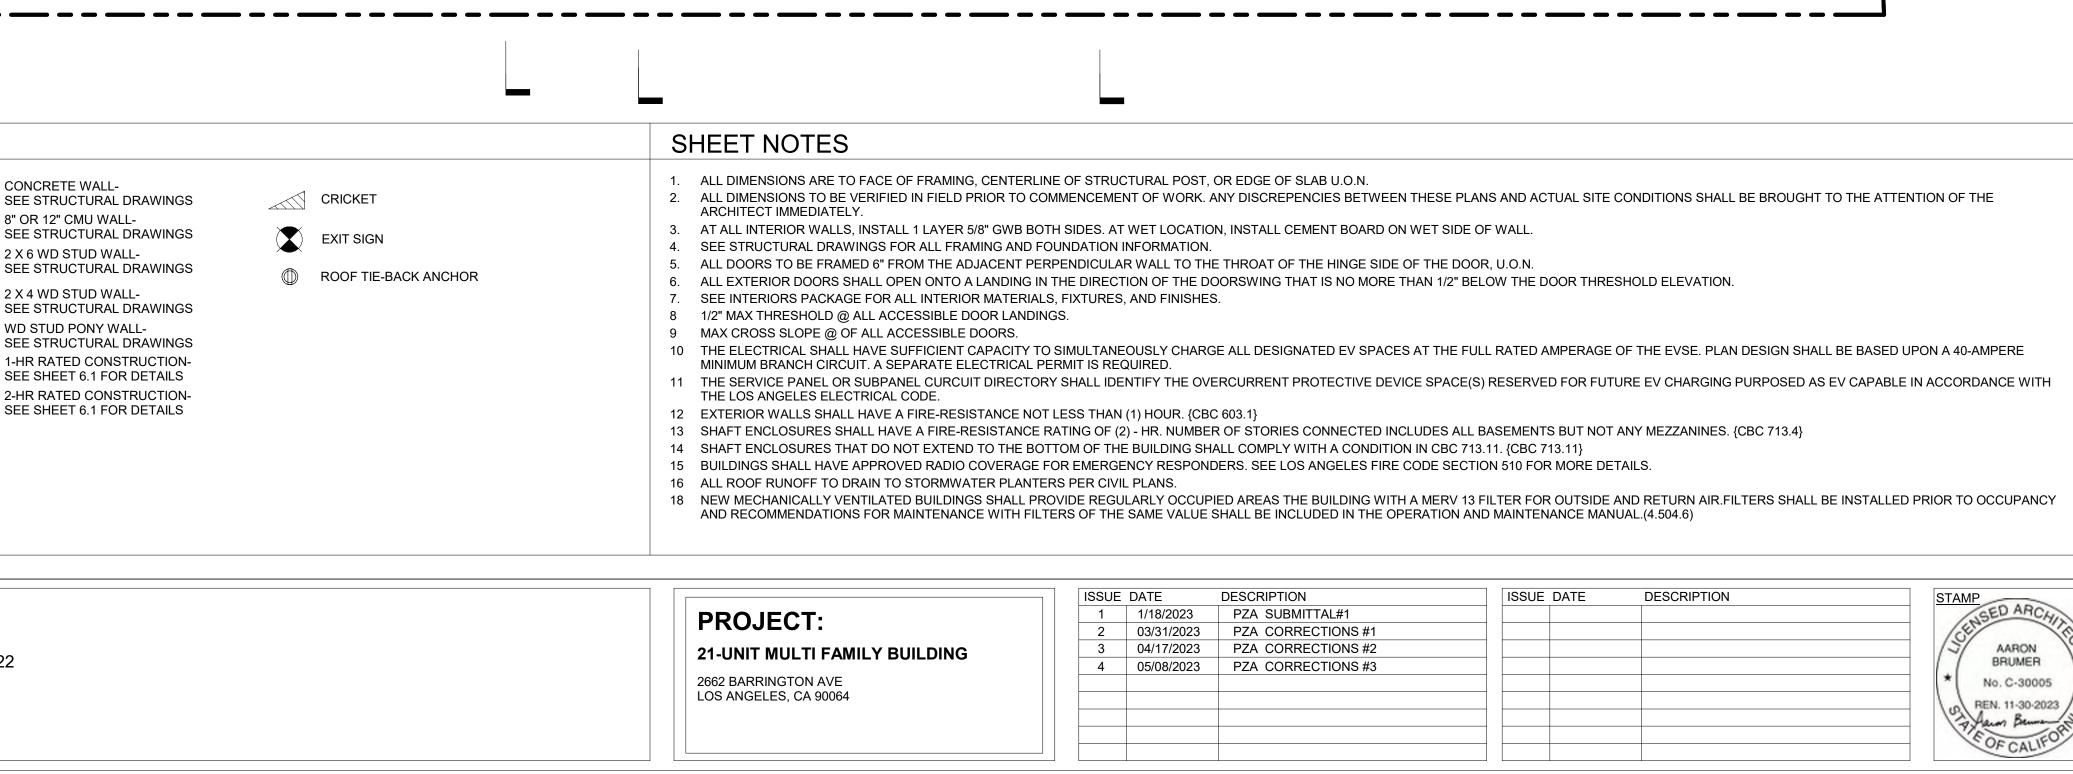
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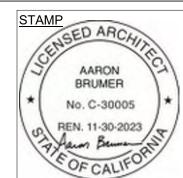


	ARCHITECT: Aaron Brumer & Assoc, Architects 10999 Riverside Drive, Suite 300 North Hollywood, CA 91602	STRUCTURAL: Amir Pirbadian, Inc. 17514 Ventura Blvd., #206 Encino, CA 91436 (818) 990-6425	CIVIL: Obando and Associates, Inc. 3101 Ocean Park Blvd., Suite #100 PMB 12 Santa Monica, CA 90405 (818) 990-6425
A STI UPPER ROOF PLAN	KEYNOTES01DOWNSPOUT02THROUGH WALL SCUPPER. CONNECT TO DOWNSPOUT/GUTTER WHERE APPLICABLE03THROUGH WALL OVERFLOW SCUPPER04ROOFING TO BE CARLISLE SPECTRO-WELD WHITE TPO, ESR-1463, CLASS A INITIAL SOLAR REFLECTANCE AFTER 3 YEARS: 0.75 THERMAL EMITTANCE = 0.89 SRI: 111 SEE SHEET A0.12 FOR SPECIFICATIONS		
	A4-01		
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DESCRIPTION	ISSUE	DATE	DESCRIPTION
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PZA CORRECTIONS #1			
PZA CORRECTIONS #2			
PZA CORRECTIONS #3			



DRAWING TITLE UPPER ROOF PLAN

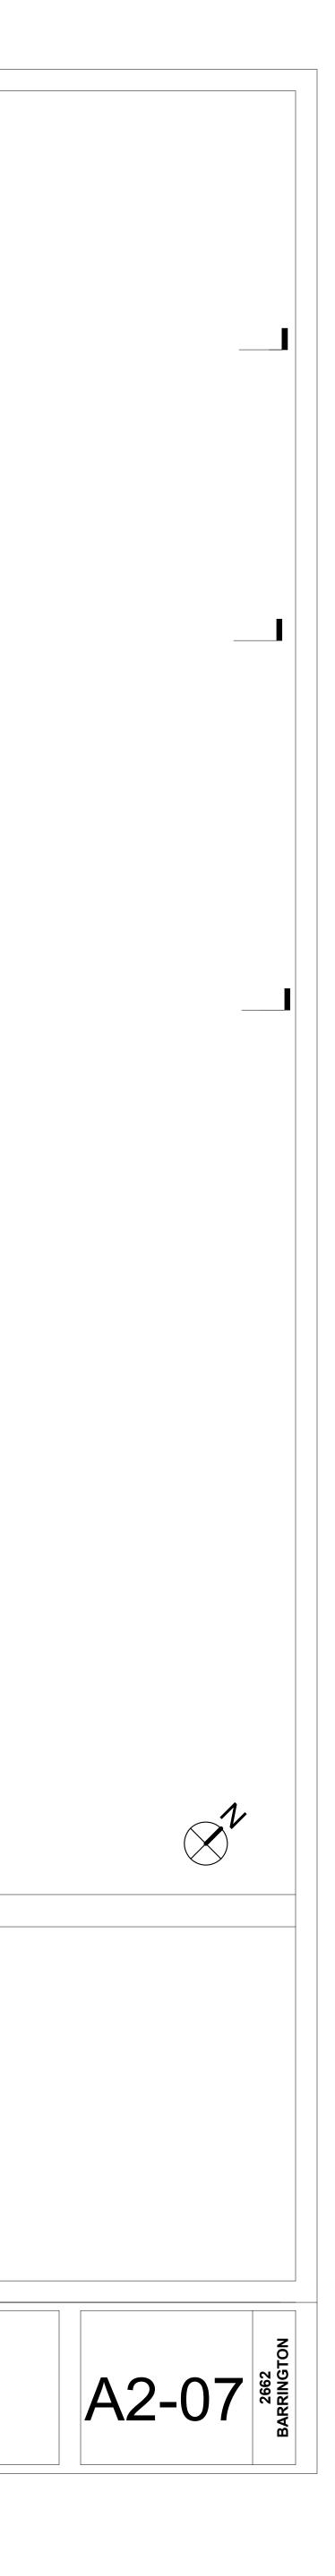
<u>STAIR #2</u>

(03)

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(02)

3-10" & 3-10"



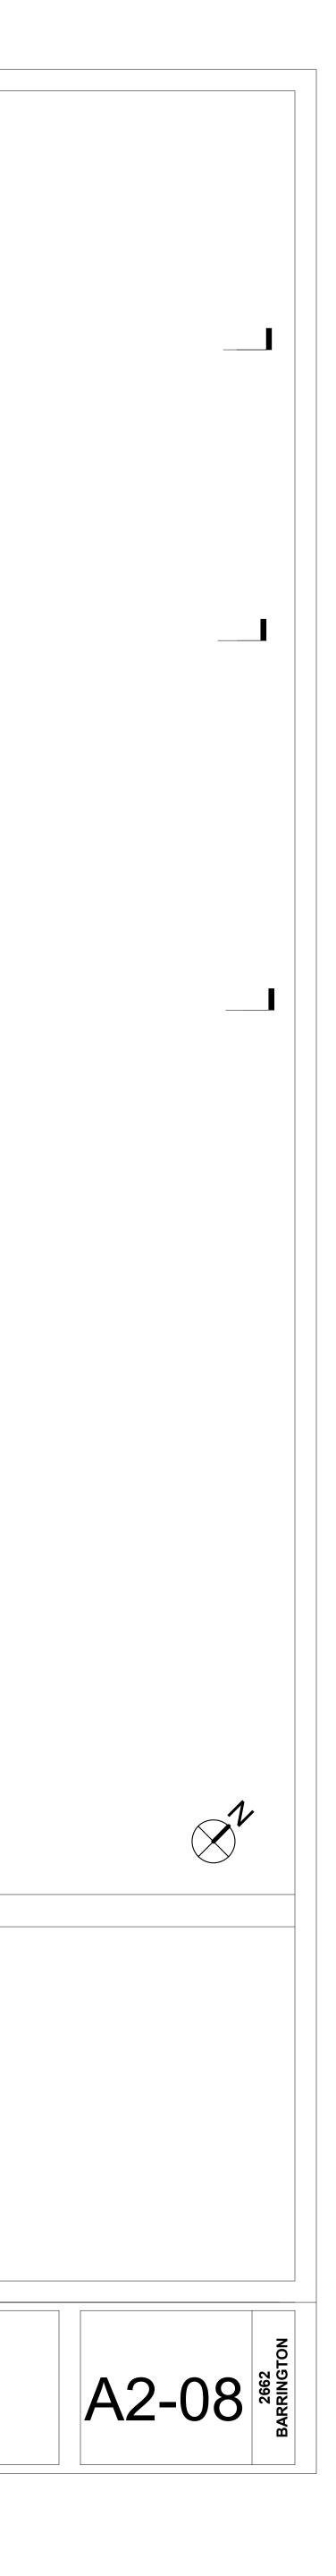

PROJECT:					
21-UNIT MULTI FAMILY BUILDING					
2662 BARRINGTON AVE					

ISSUE	DATE	DESCRIPTION	ISSUE DATE	DESCRIPTION	STAMP	DRAWING
1	1/18/2023	PZA SUBMITTAL#1			SED ARCHIN	
2	03/31/2023	PZA CORRECTIONS #1			CE TO	WESTE
3	04/17/2023	PZA CORRECTIONS #2			J AARON 3	
4	05/08/2023	PZA CORRECTIONS #3			BRUMER	
					* No. C-30005 *	
					BEN 11-30-2023	
					Agun Berner St	
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PROJECT:				
21-UNIT MULTI FAMILY BUILDING				
2662 BARRINGTON AVE LOS ANGELES, CA 90064				


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1	1/18/2023	PZA SUBMITTAL#1			SED ARCHIN	
2	03/31/2023	PZA CORRECTIONS #1			CE TE	NORTH
3	04/17/2023	PZA CORRECTIONS #2			J AARON (S)	
4	05/08/2023	PZA CORRECTIONS #3			BRUMER	
					* No. C-30005 *	
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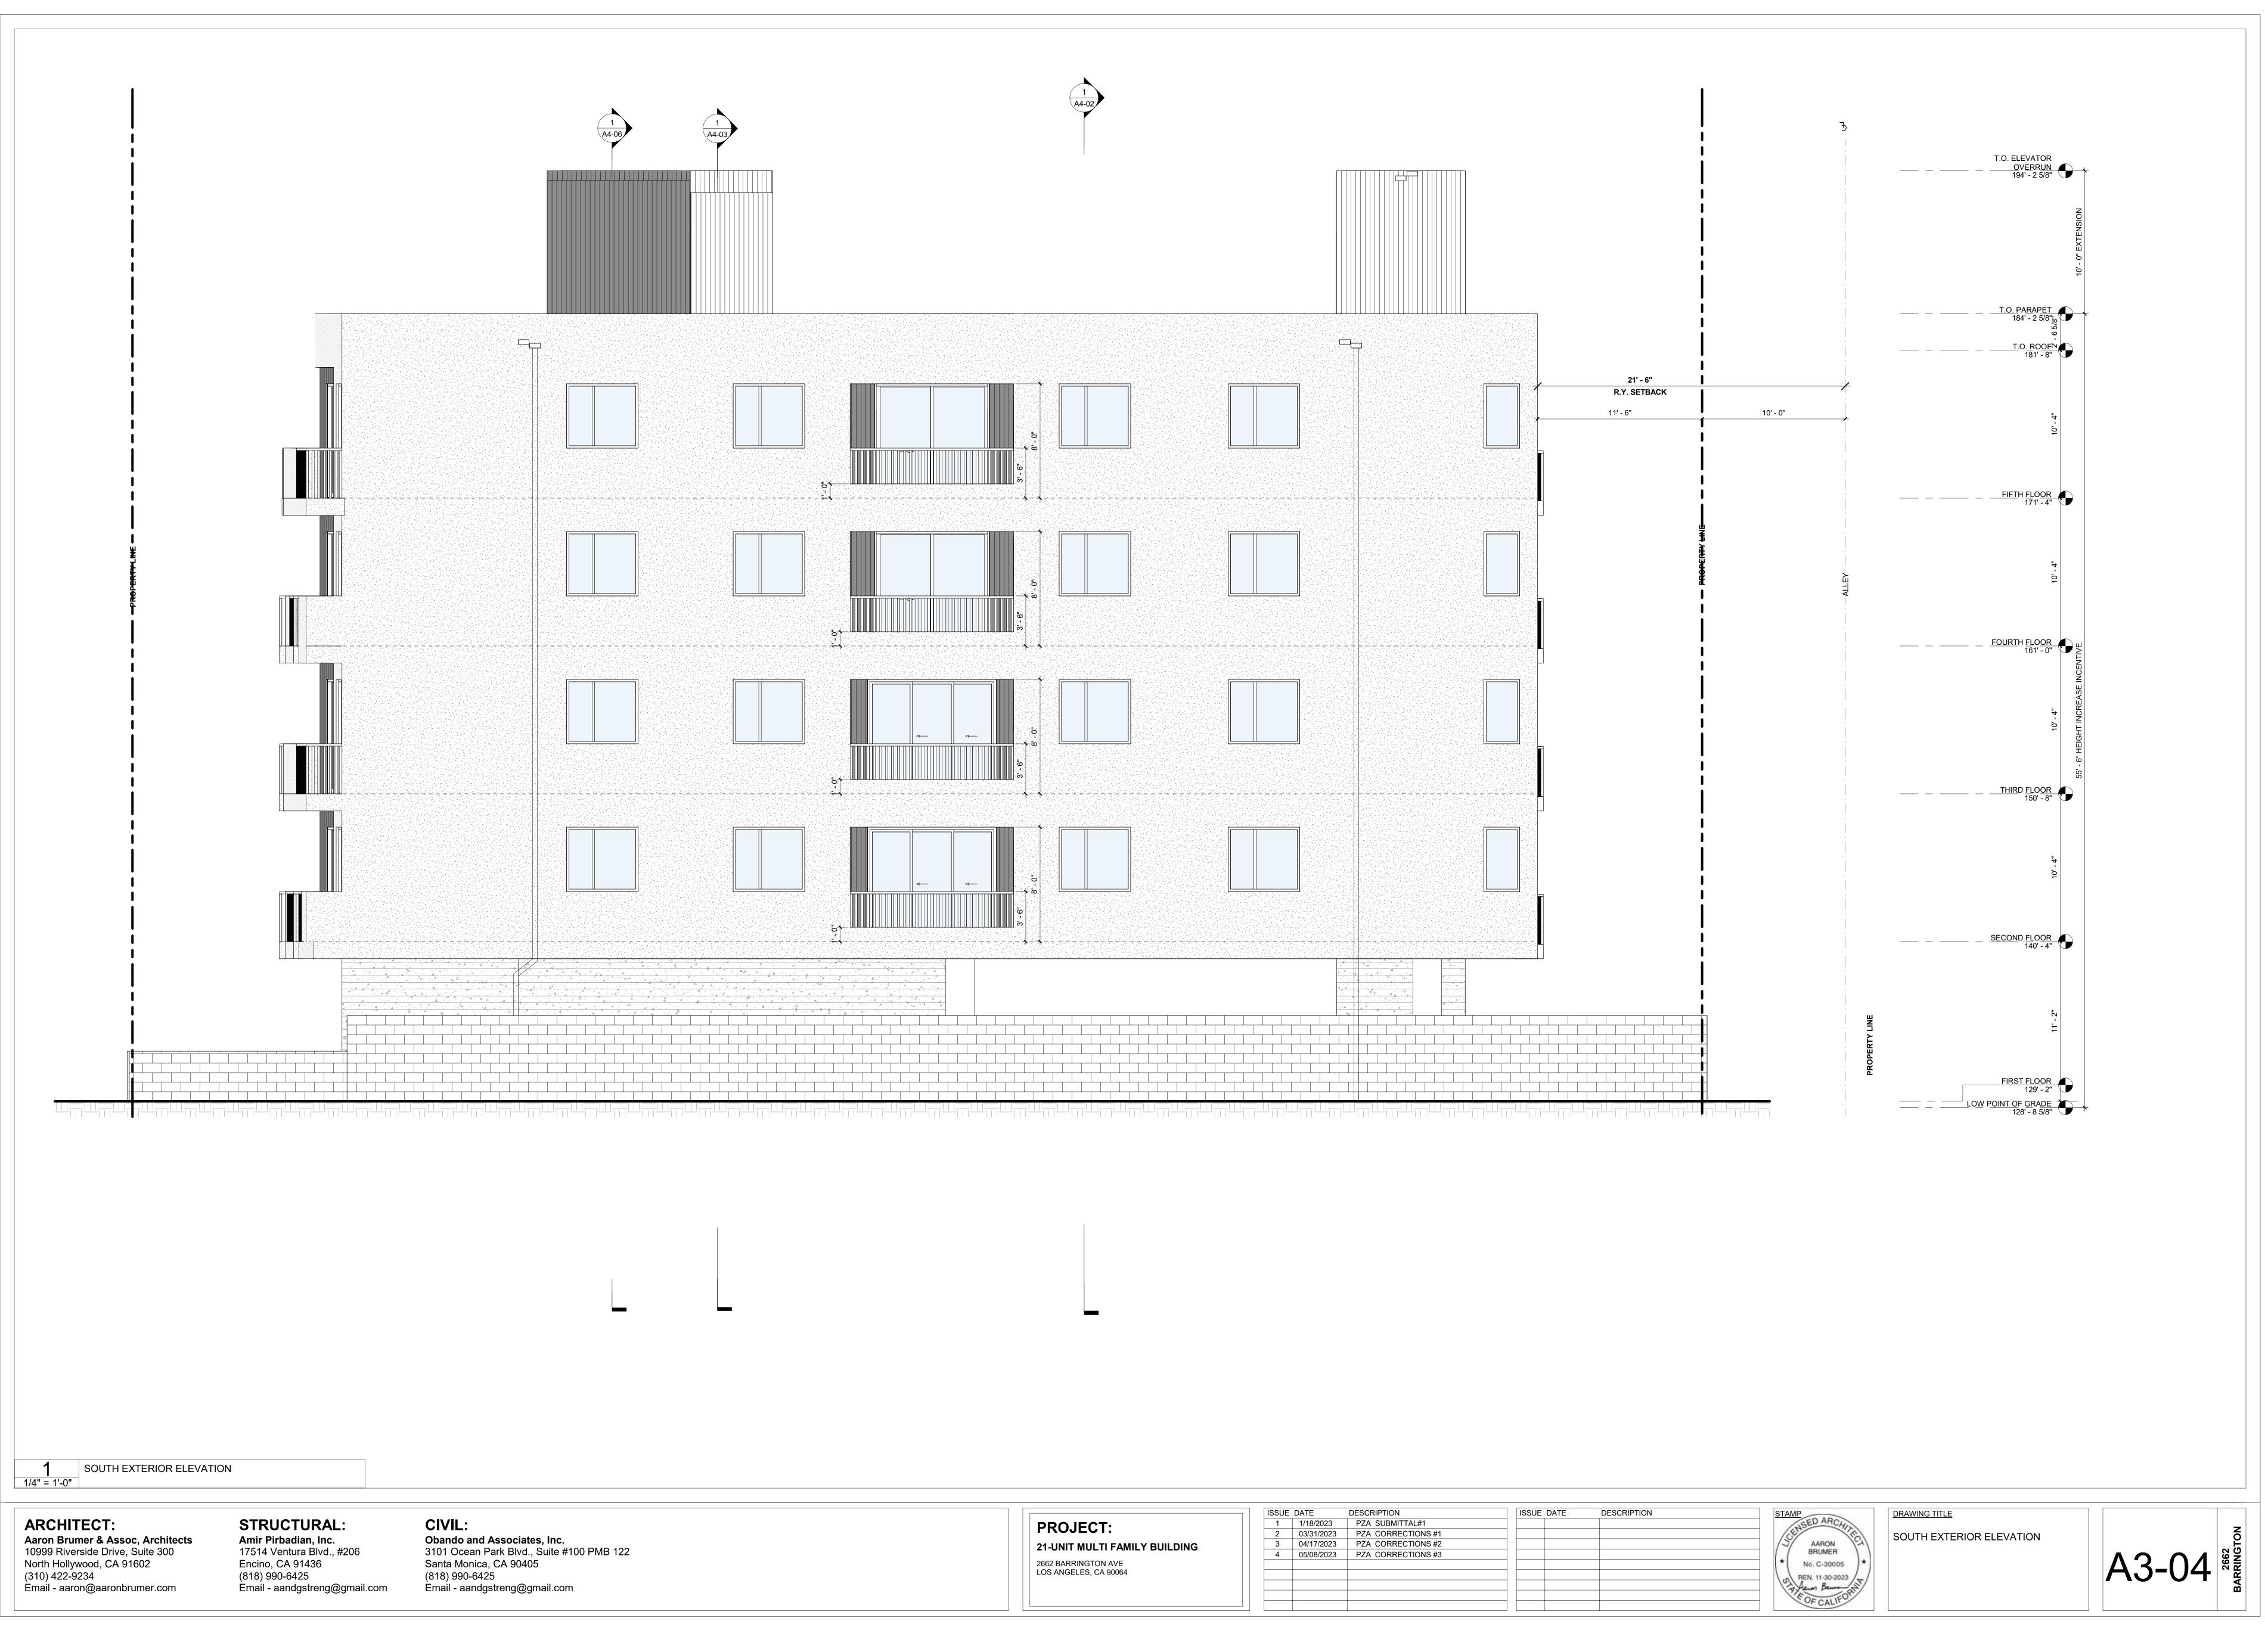


PROJECT:	
21-UNIT MULTI FAMILY BUILDING	
2662 BARRINGTON AVE LOS ANGELES, CA 90064	

ISSUE	DATE
1	1/18/2023
2	03/31/2023
3	04/17/2023
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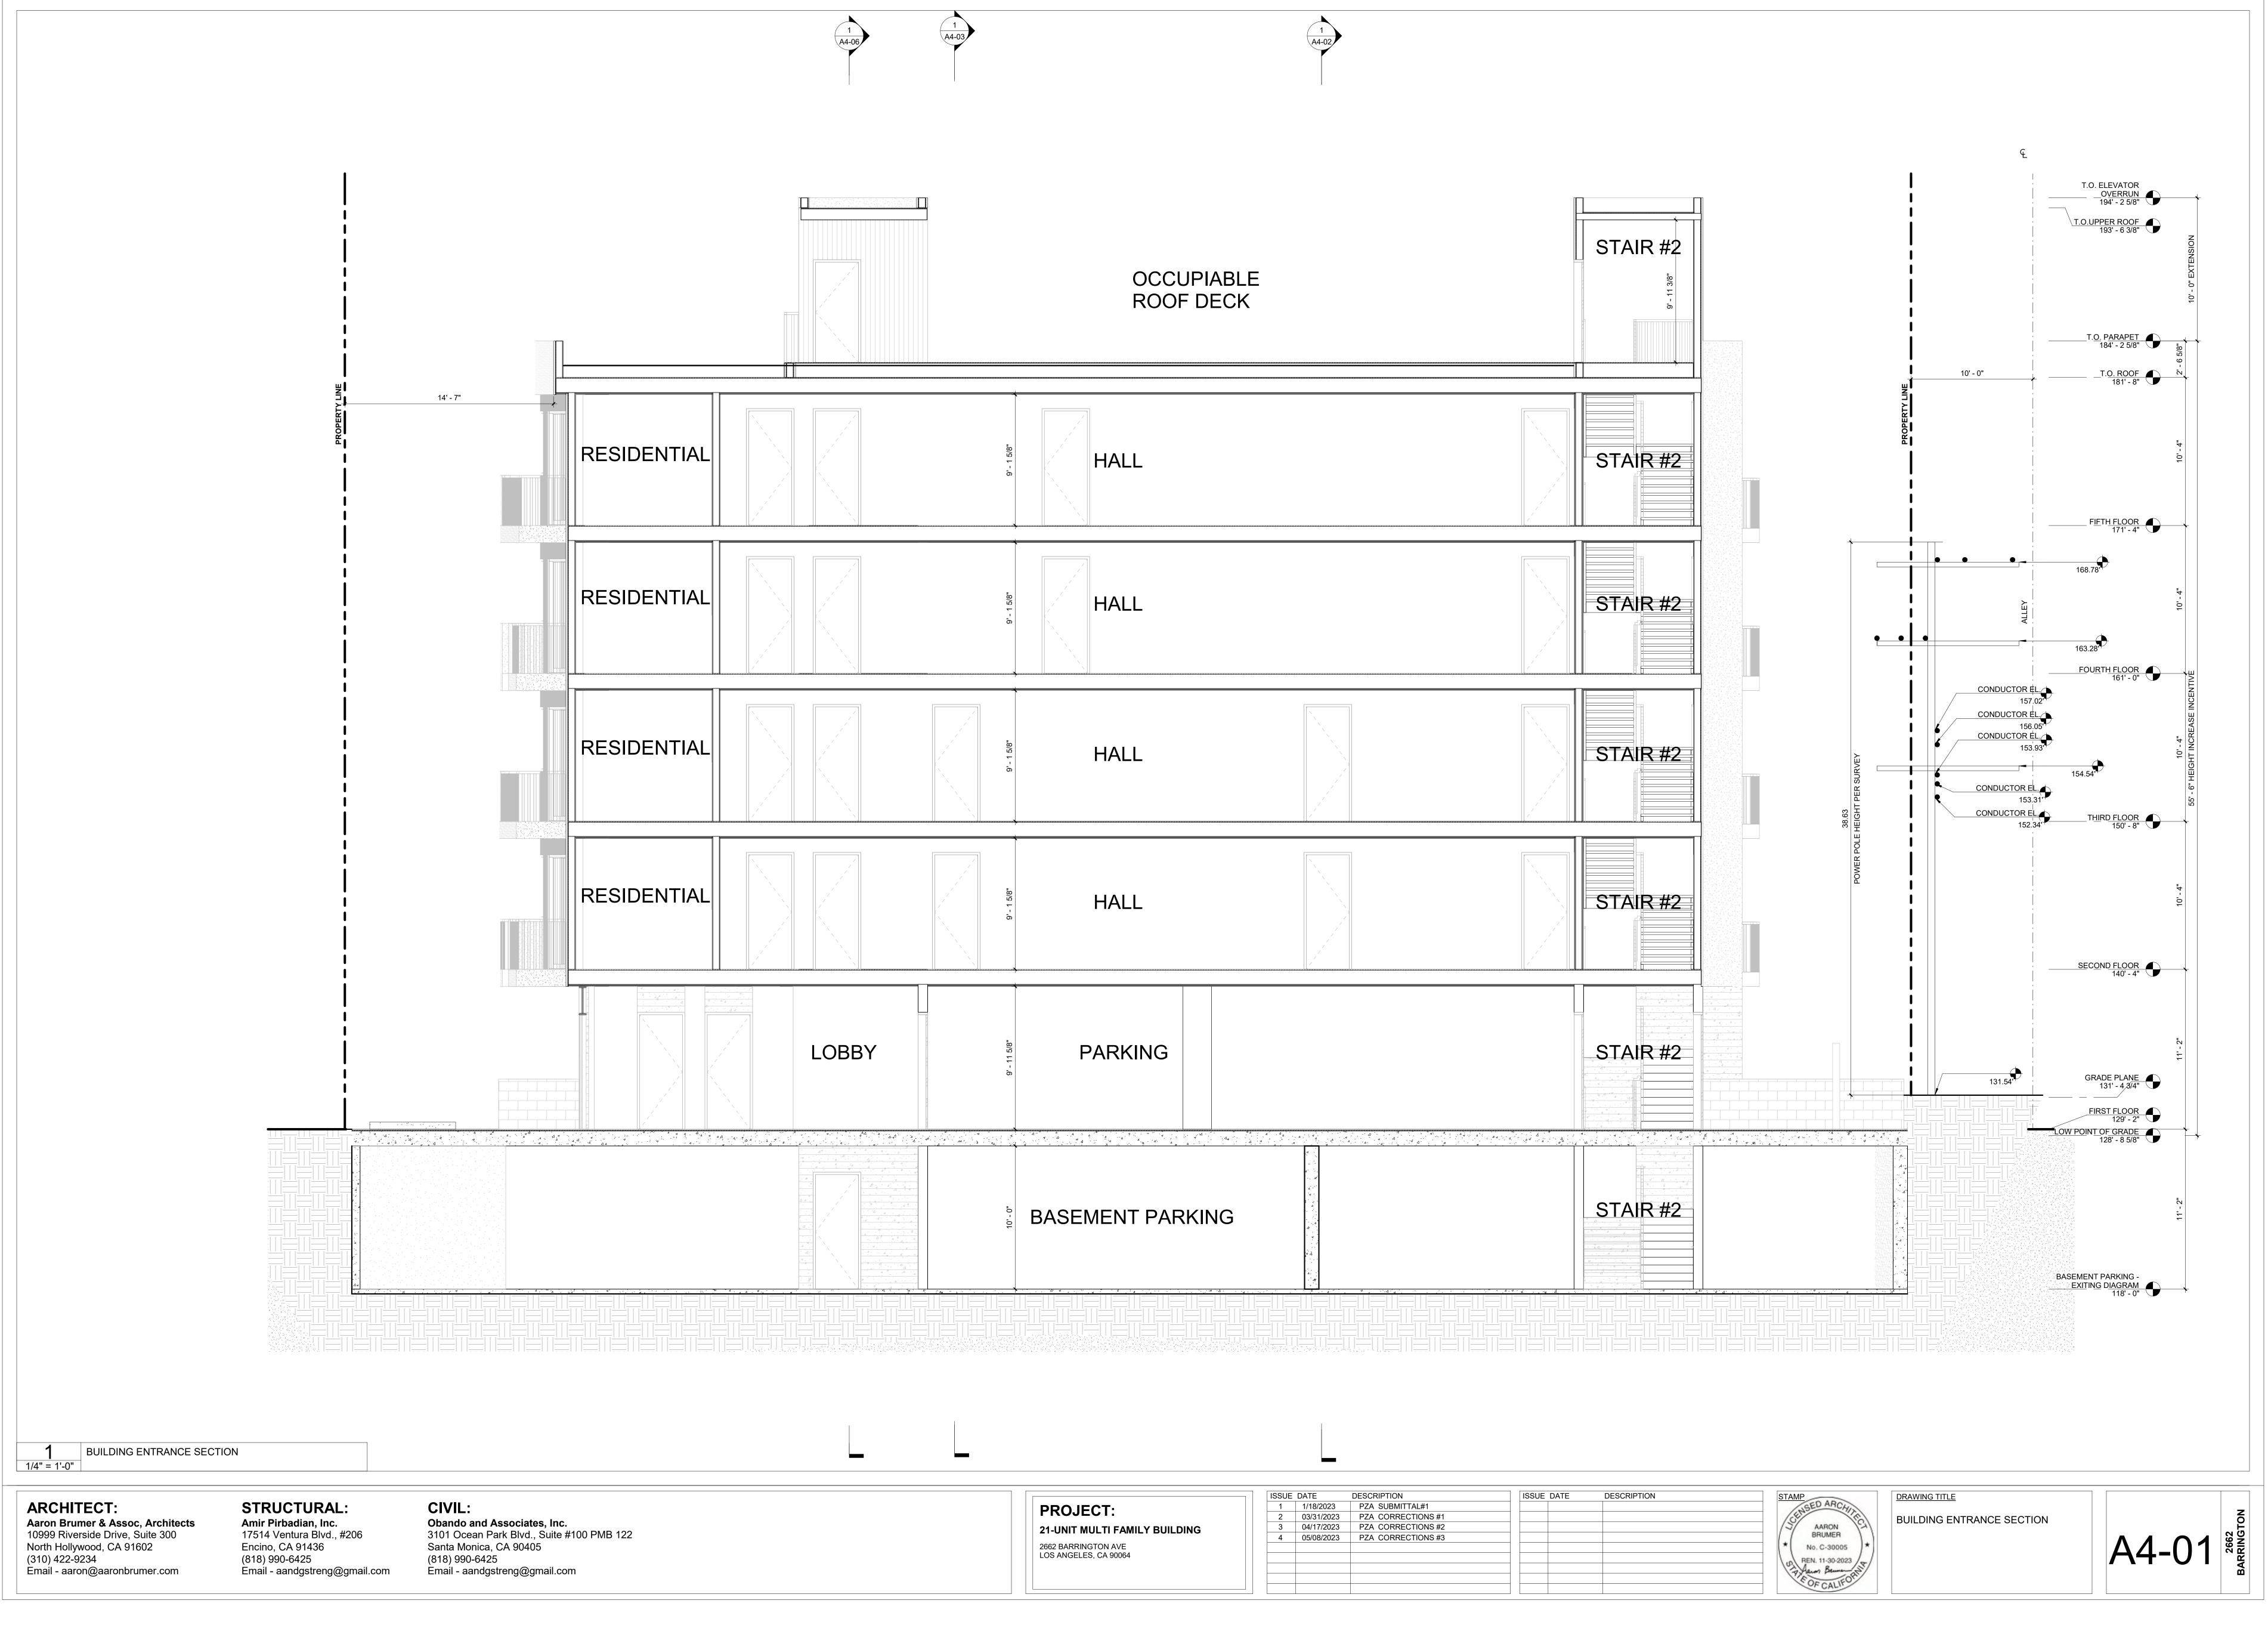
	DESCRIPTION	ISSUE DATE	DESCRIPTION	STAMP	DRAWING TITLE
	PZA SUBMITTAL#1			SED ARCHIN	
3	PZA CORRECTIONS #1			Car In	EAST EXTERIOR ELEVA
3	PZA CORRECTIONS #2			J AARON SA	
3	PZA CORRECTIONS #3			BRUMER	
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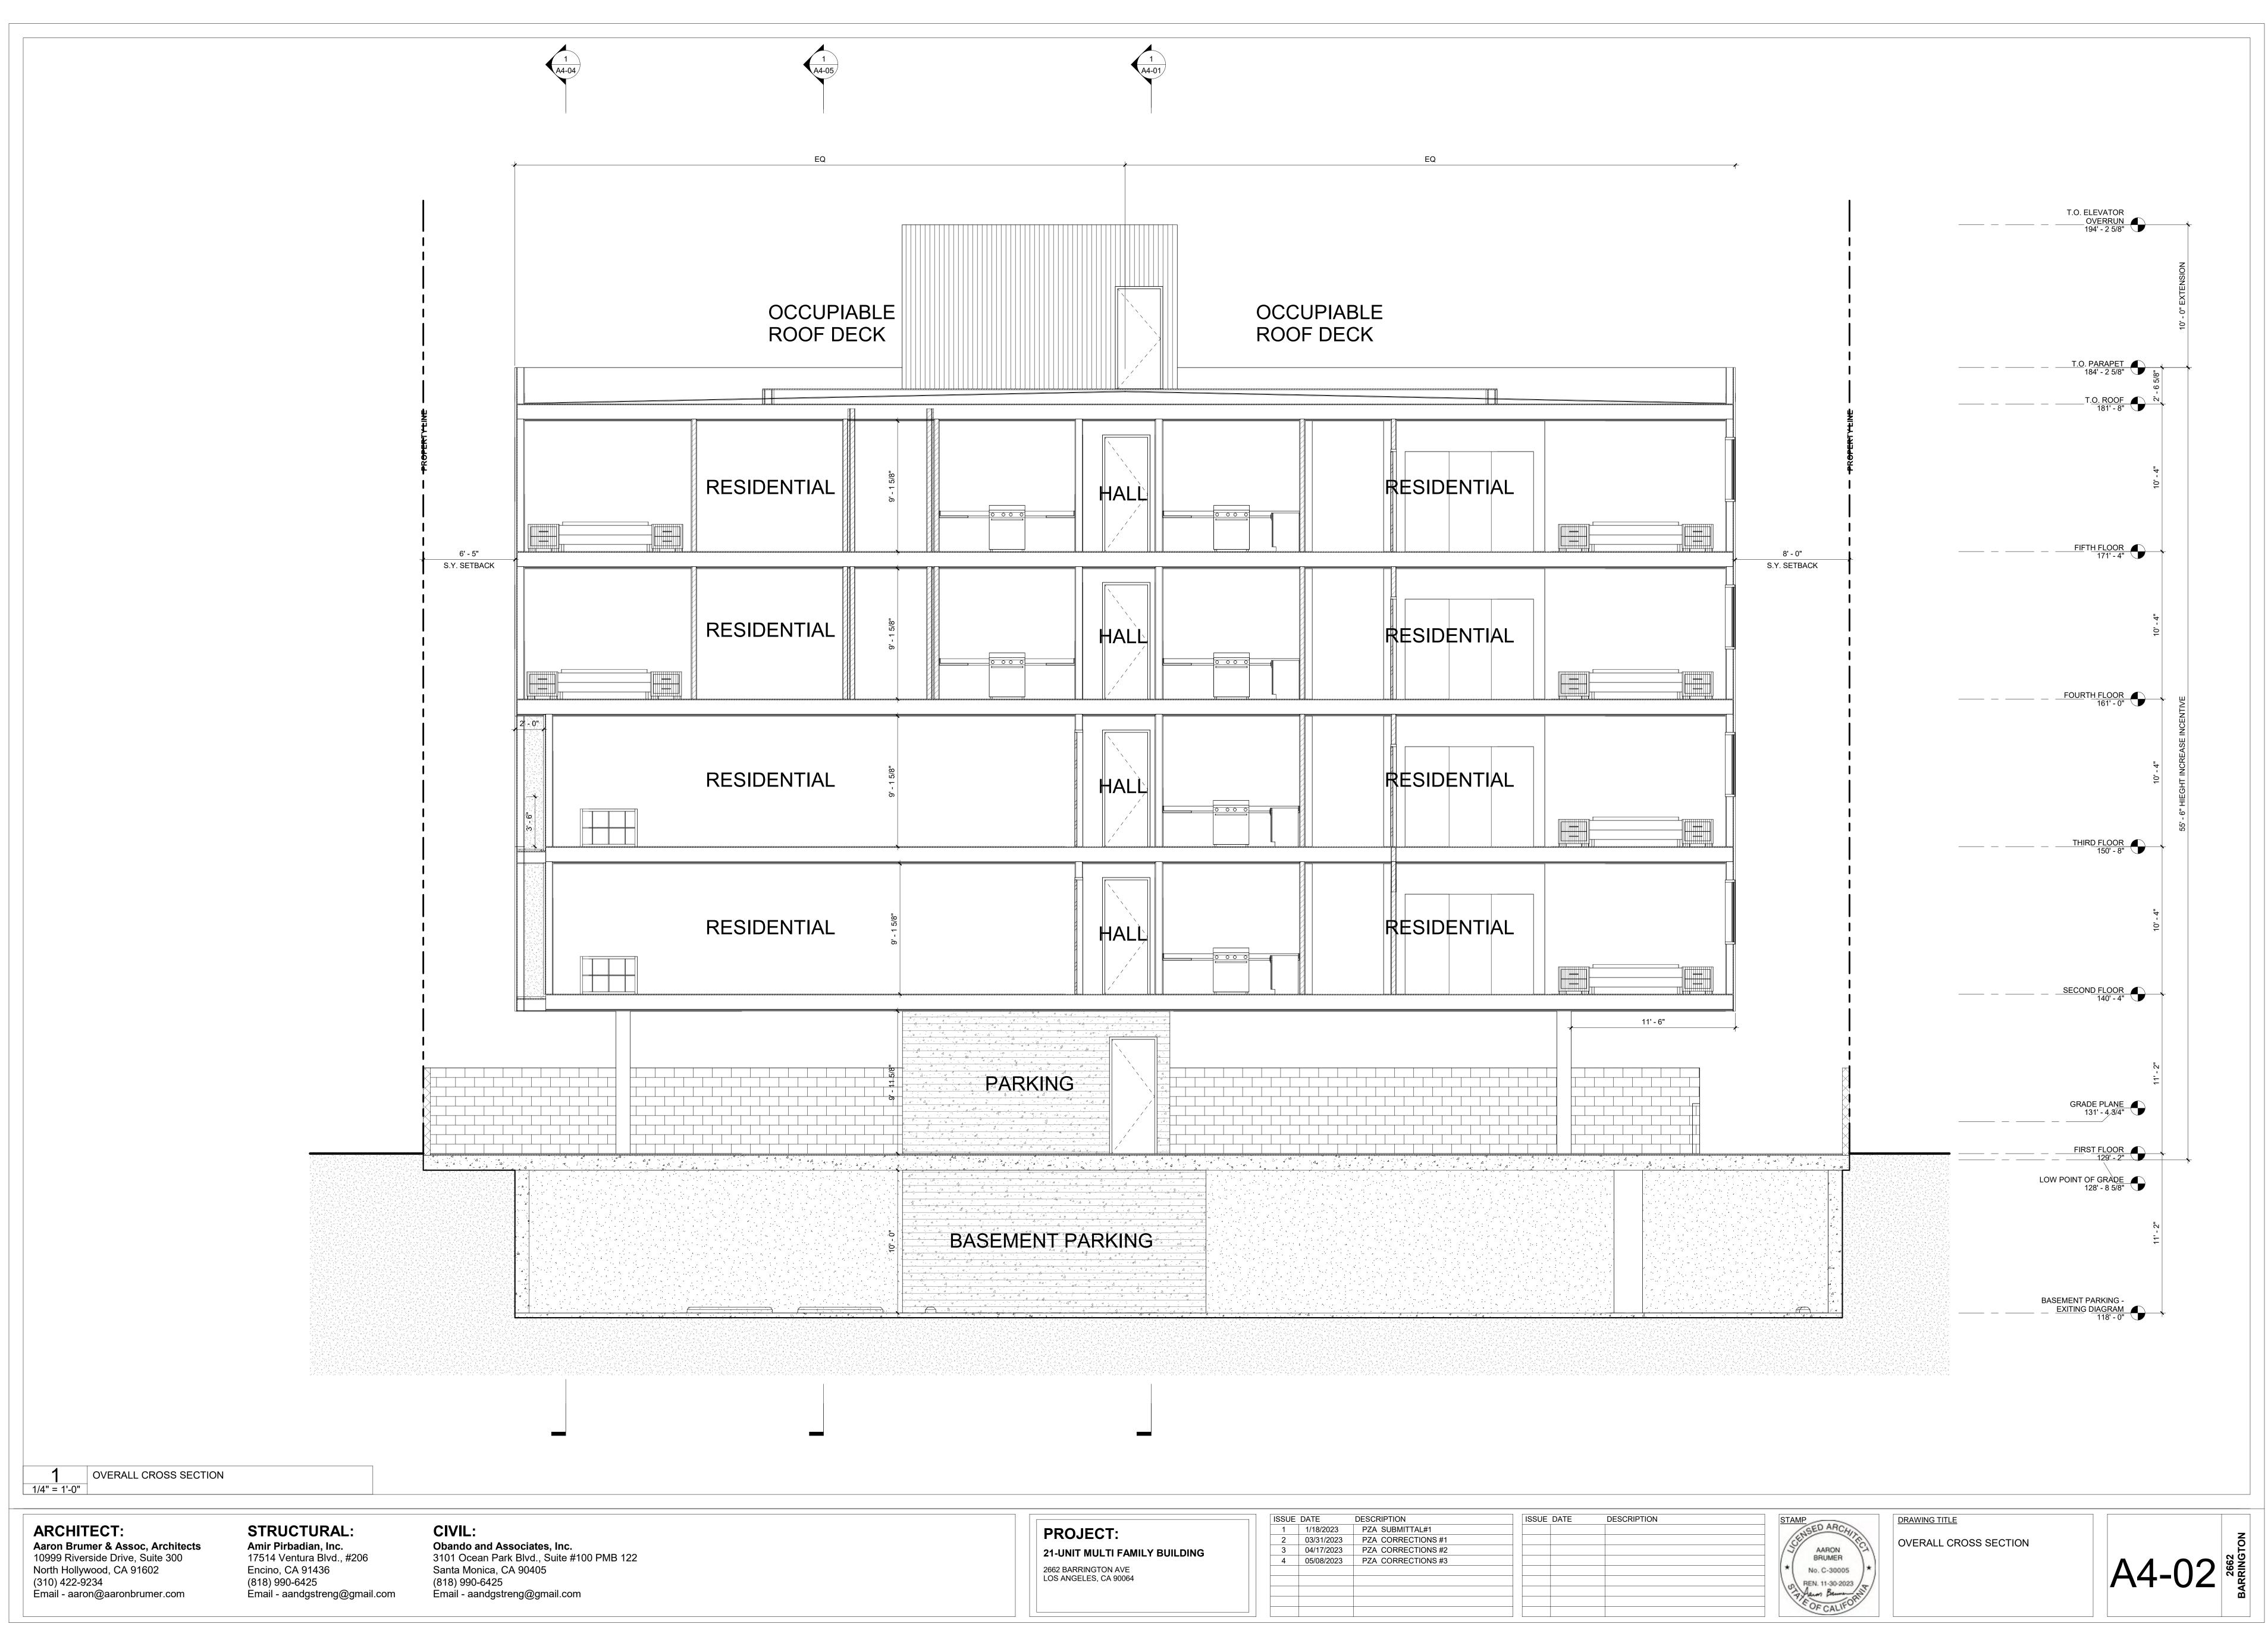


PRUJECT:
21-UNIT MULTI FAMILY BUILDING
2662 BARRINGTON AVE LOS ANGELES, CA 90064


ISSUE	DATE	DESCRIPTION	ISSUE DATE	DESCRIPTION	STAMP	DRAWING TIT
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3	04/17/2023	PZA CORRECTIONS #2			J AARON	COUTTER
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DESCRIPTION	ISSUE DATE	DESCRIPTION	STAMP
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DESCRIPTION	ISSUE DATE	DESCRIPTION	STAMP
PZA SUBMITTAL#1			SED ARCHIN
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North Hollywood, CA 91602 (310) 422-9234 Email - aaron@aaronbrumer.com

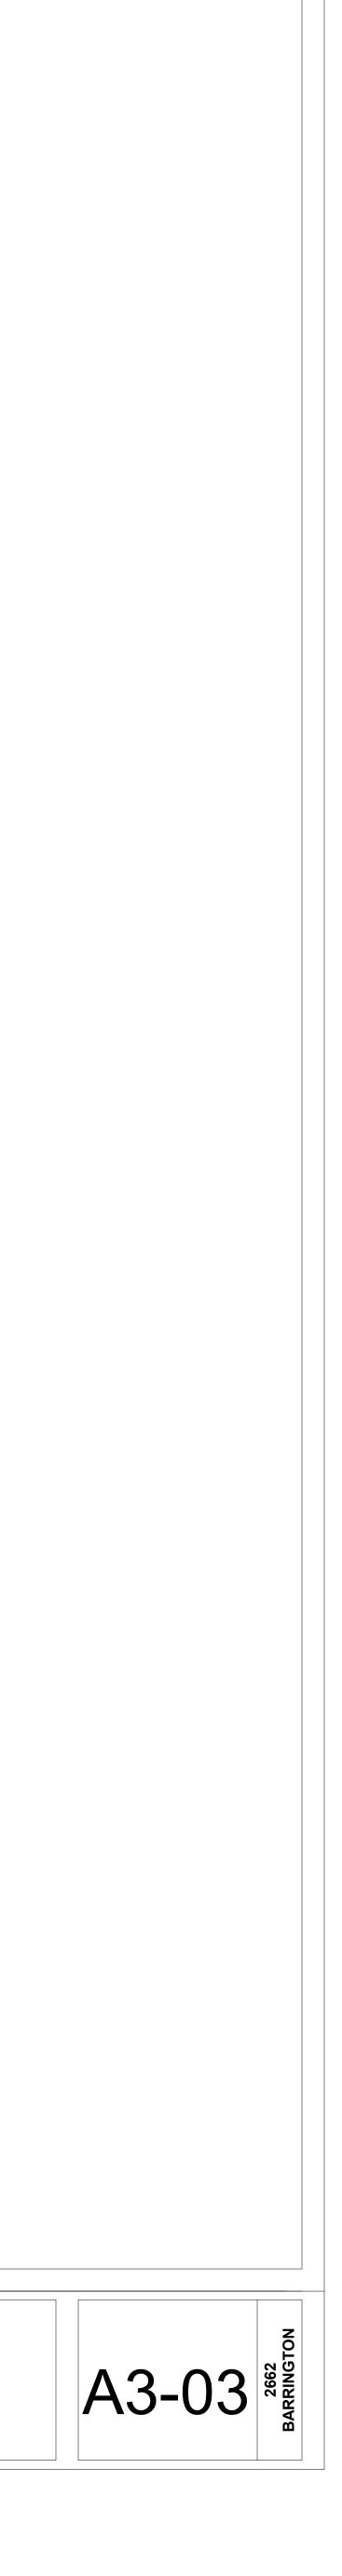
		ISSUE	DATE
PROJECT:		1	1/18/2023
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21-UNIT MULTI FAMILY BUILDING		3	04/17/2023
		4	05/08/2023
2662 BARRINGTON AVE			
LOS ANGELES, CA 90064			


OCCUPIABLE ROOF DECK	
	8' - 0" S.Y. SETBACK
	THIRD FLOOR
	8' - 0"
	GRADE PLANE 131' - 4,3/4"
	FIRST FLOOR — 129' - 2"
	LOW POINT OF GRADE 128' - 8 5/8"
BASEMENT PARKING	
	BASEMENT PARKING - EXITING DIAGRAM 118' - 0"
가 있는 것 같아요. 이것 같아요. 그는 것 같아요. 이것 이 것 같아요. 이것 같아요. 이것 같아요. 것이 것 같아요. 이것 같아요. 한 것 같아요. 한 것이 같아요. 한 것 같아요. 한 것이 같아 같아요. 이것 같아요. 이것	수는 것은 것은 것은 것을 해외에 있는 것은

DESCRIPTION	ISSUE DATE	DESCRIPTION	STAMP
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DRAWING TITLE

STAIR #1 SECTION

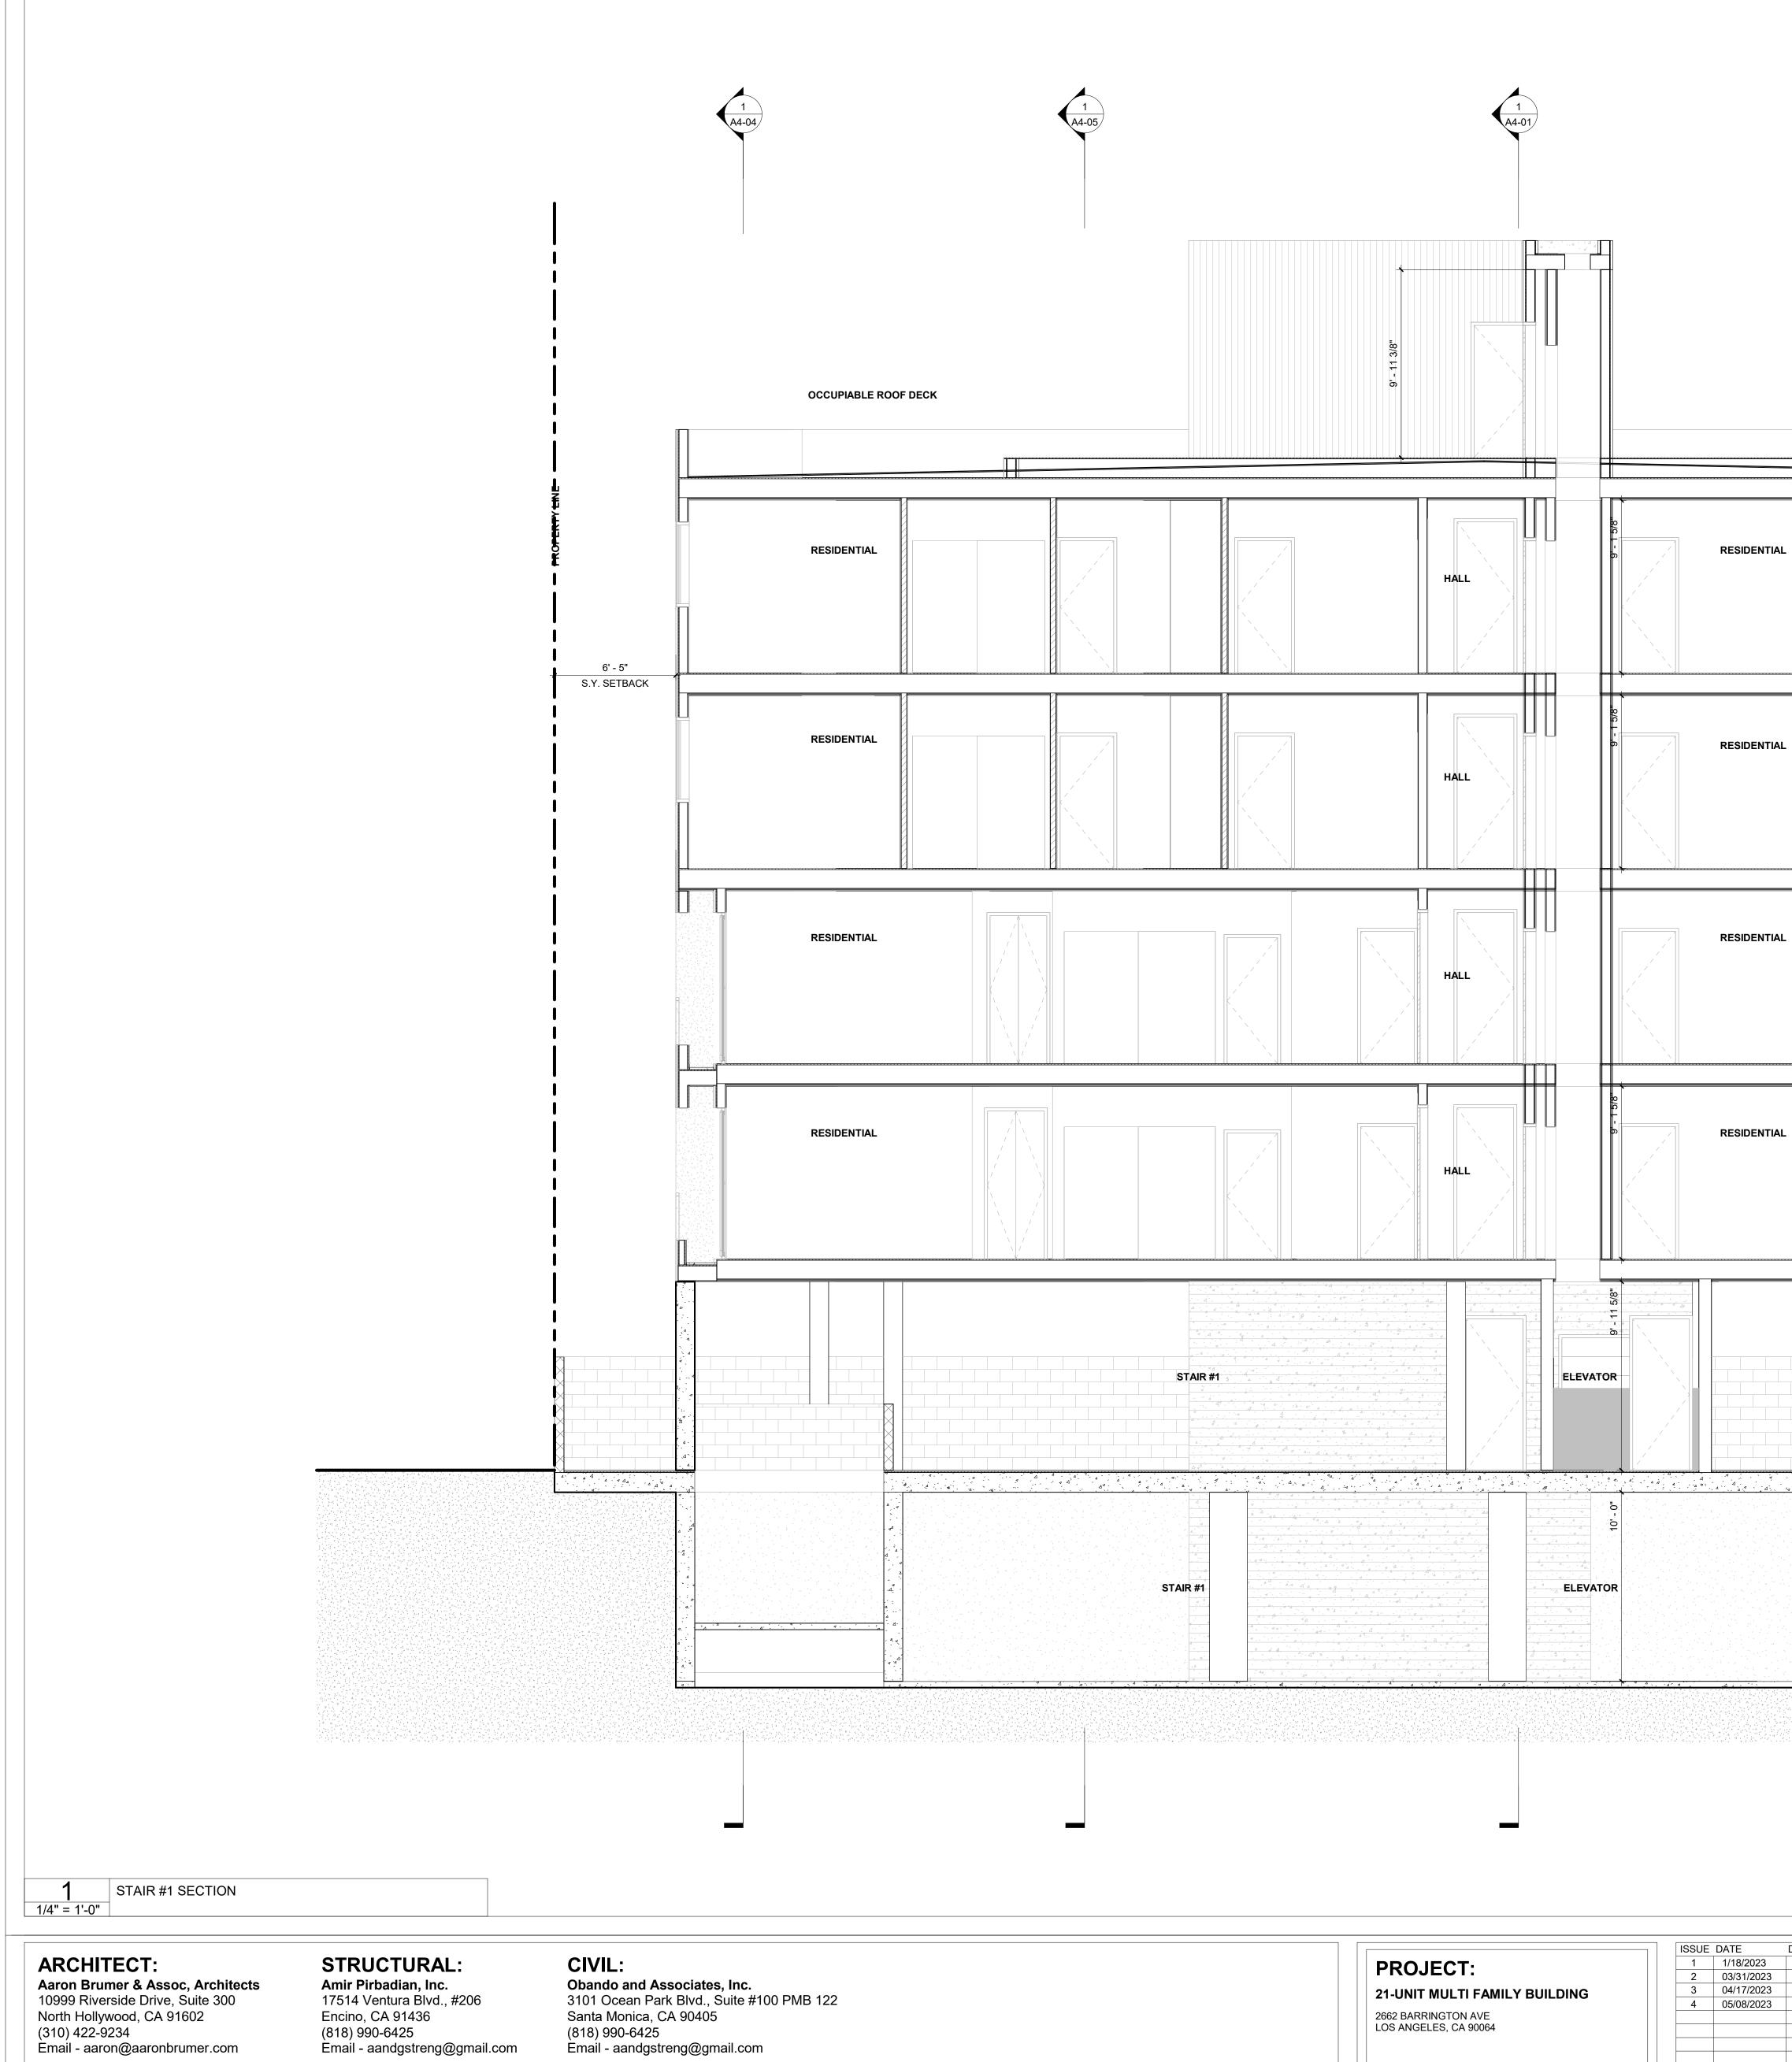

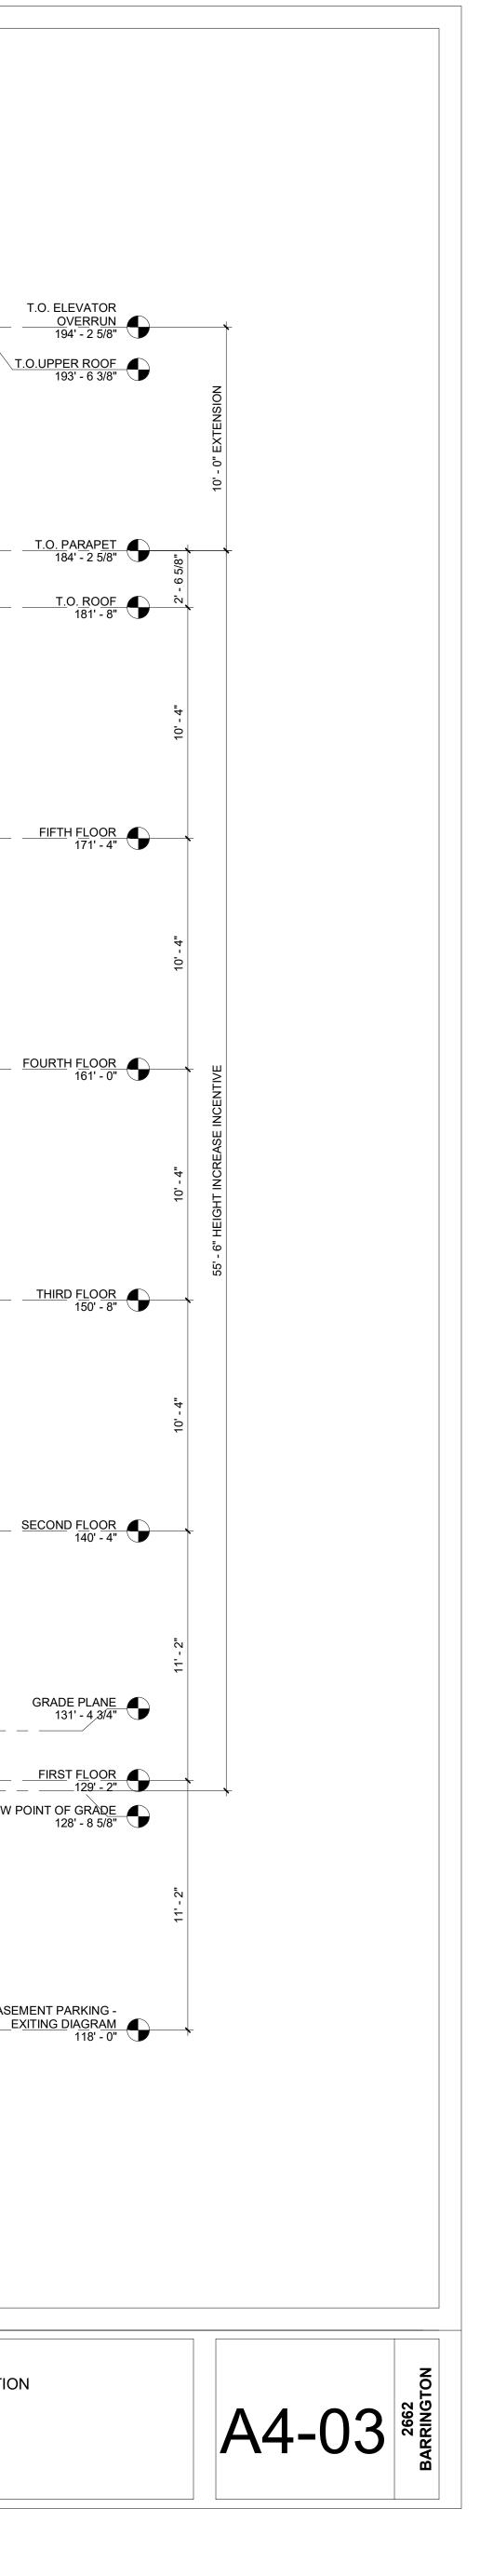

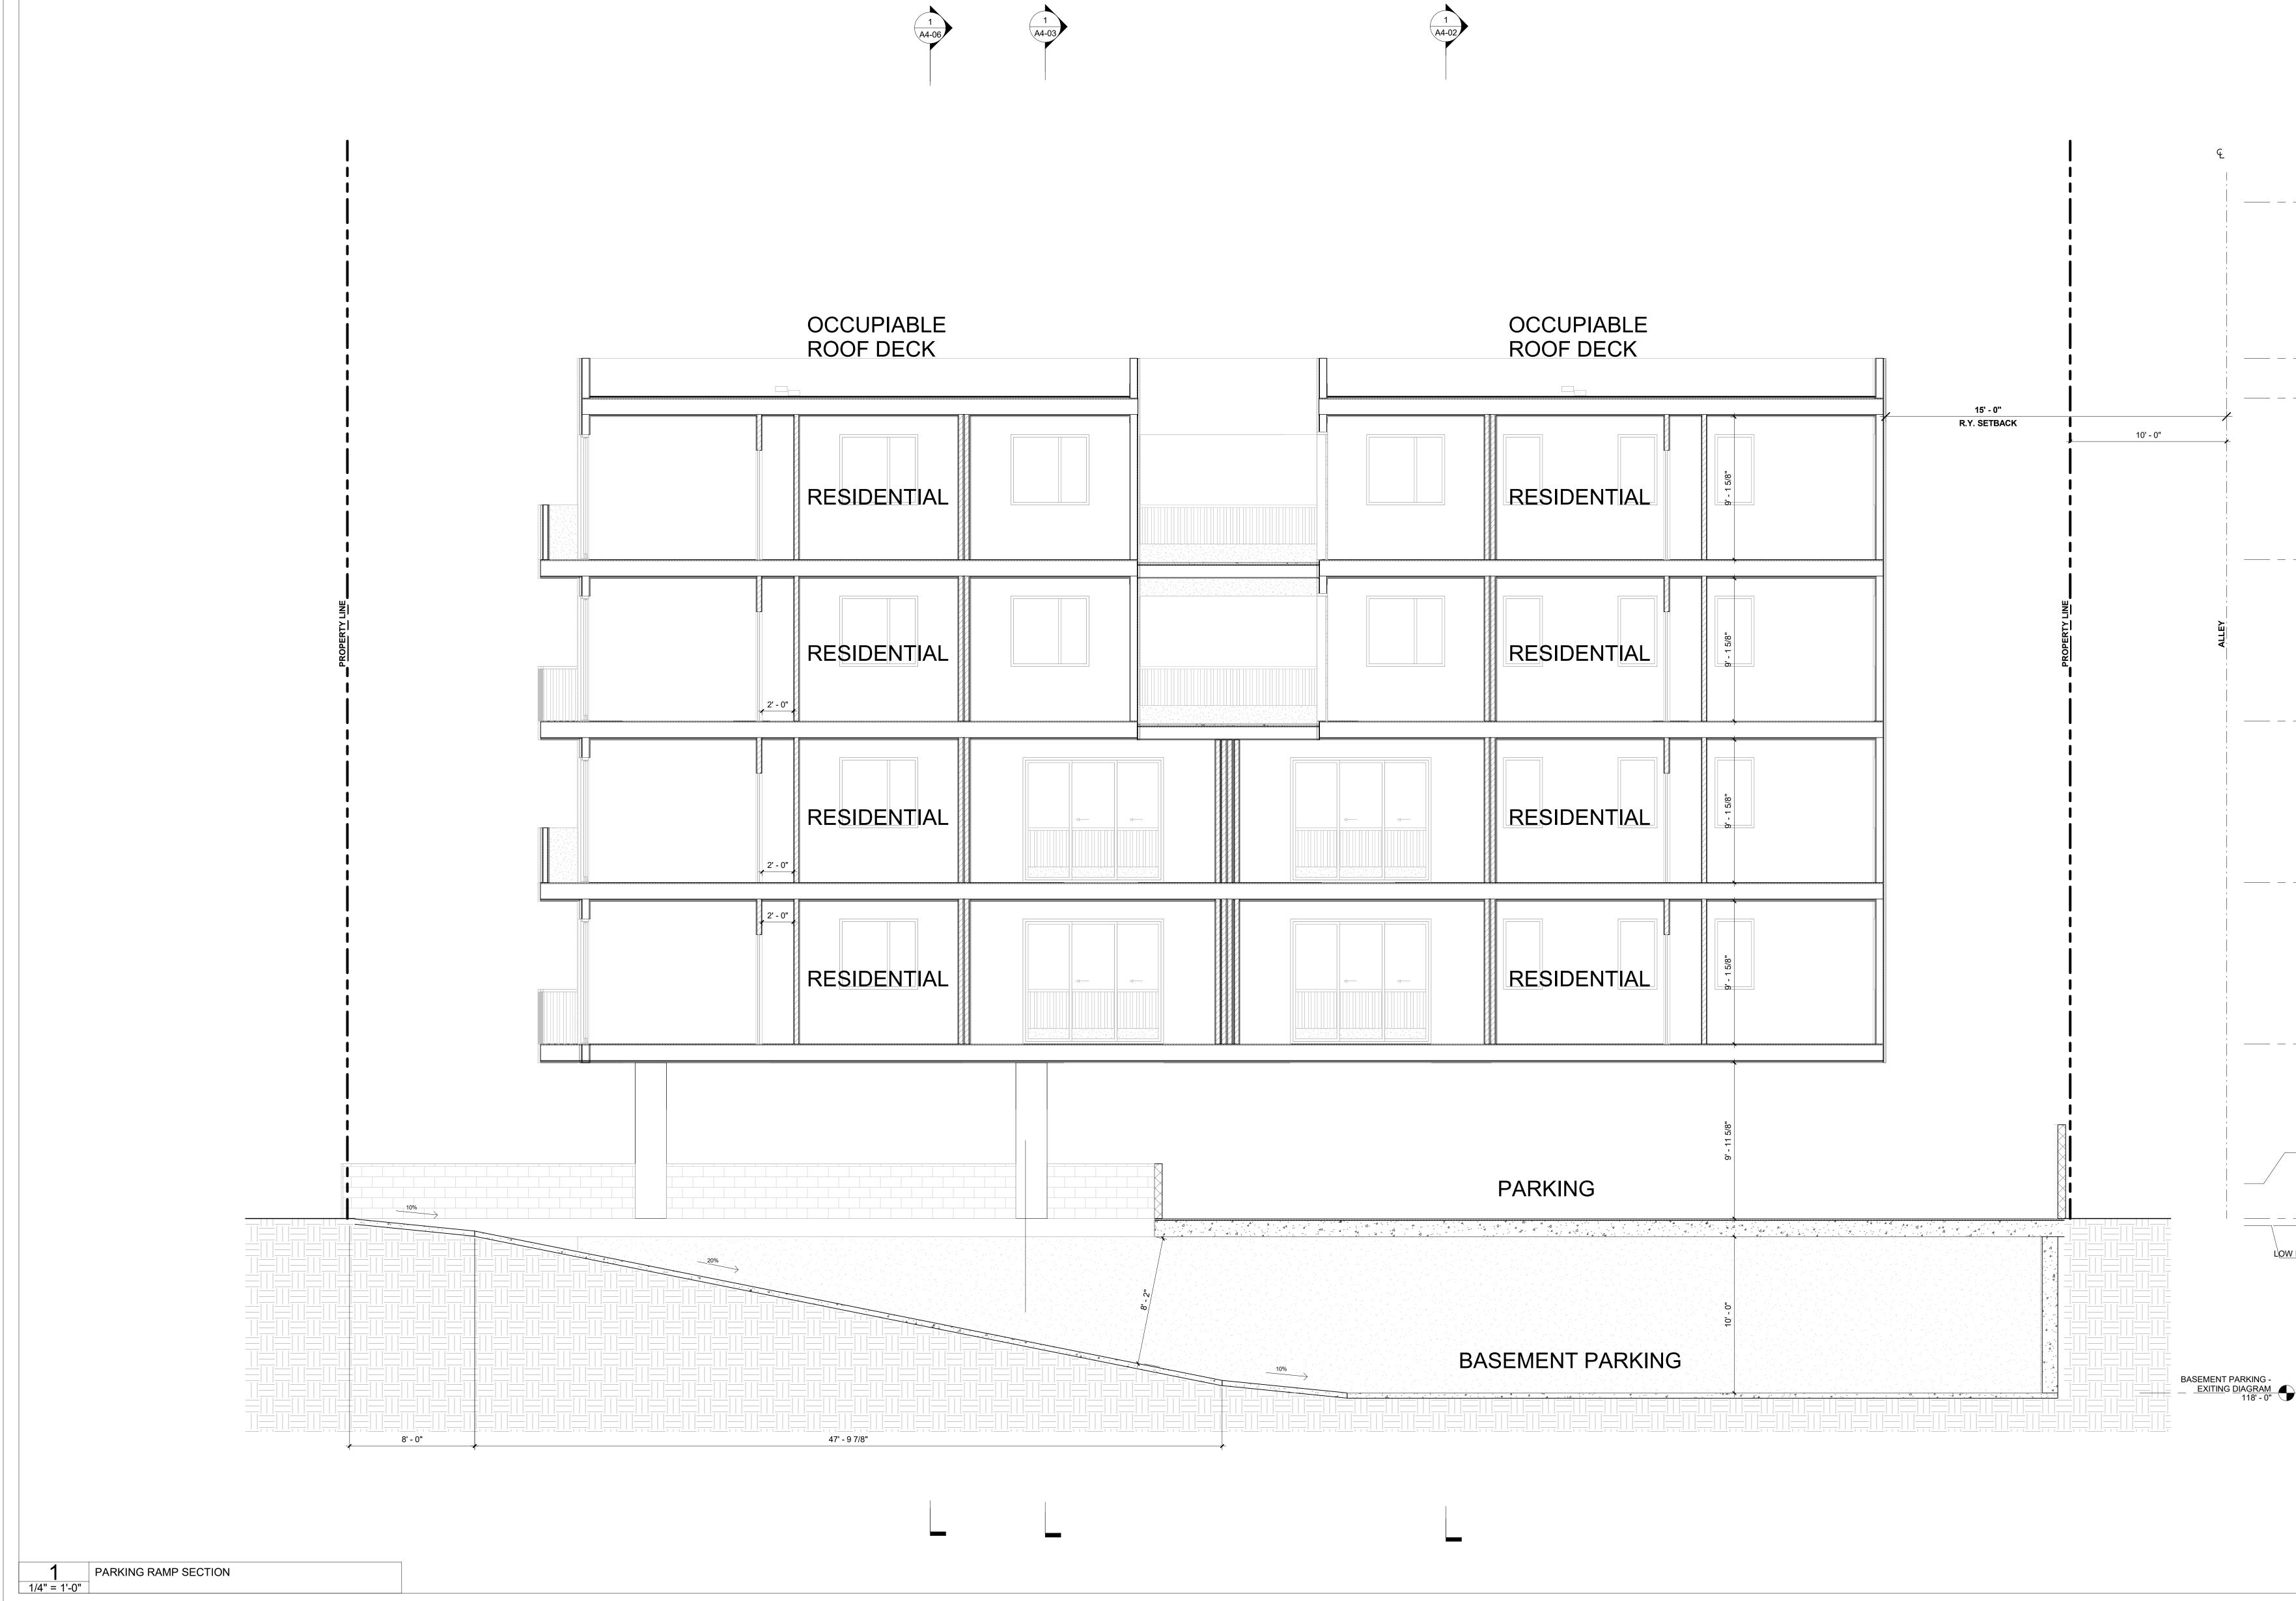
ARCHITECT:

Aaron Brumer & Assoc, Architects 10999 Riverside Drive, Suite 300 North Hollywood, CA 91602 (310) 422-9234 Email - aaron@aaronbrumer.com STRUCTURAL: Amir Pirbadian, Inc. 17514 Ventura Blvd., #206 Encino, CA 91436 (818) 990-6425


Email - aandgstreng@gmail.com

CIVIL:


Obando and Associates, Inc. 3101 Ocean Park Blvd., Suite #100 PMB 122 Santa Monica, CA 90405 (818) 990-6425 Email - aandgstreng@gmail.com PROJECT: 21-UNIT MULTI FAMILY BUILDING 2662 BARRINGTON AVE LOS ANGELES, CA 90064

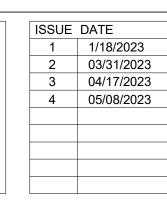


DESCRIPTION	ISSUE DATE	DESCRIPTION	
PZA SUBMITTAL#1			
PZA CORRECTIONS #1			
PZA CORRECTIONS #2			
PZA CORRECTIONS #3			

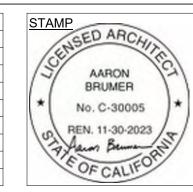

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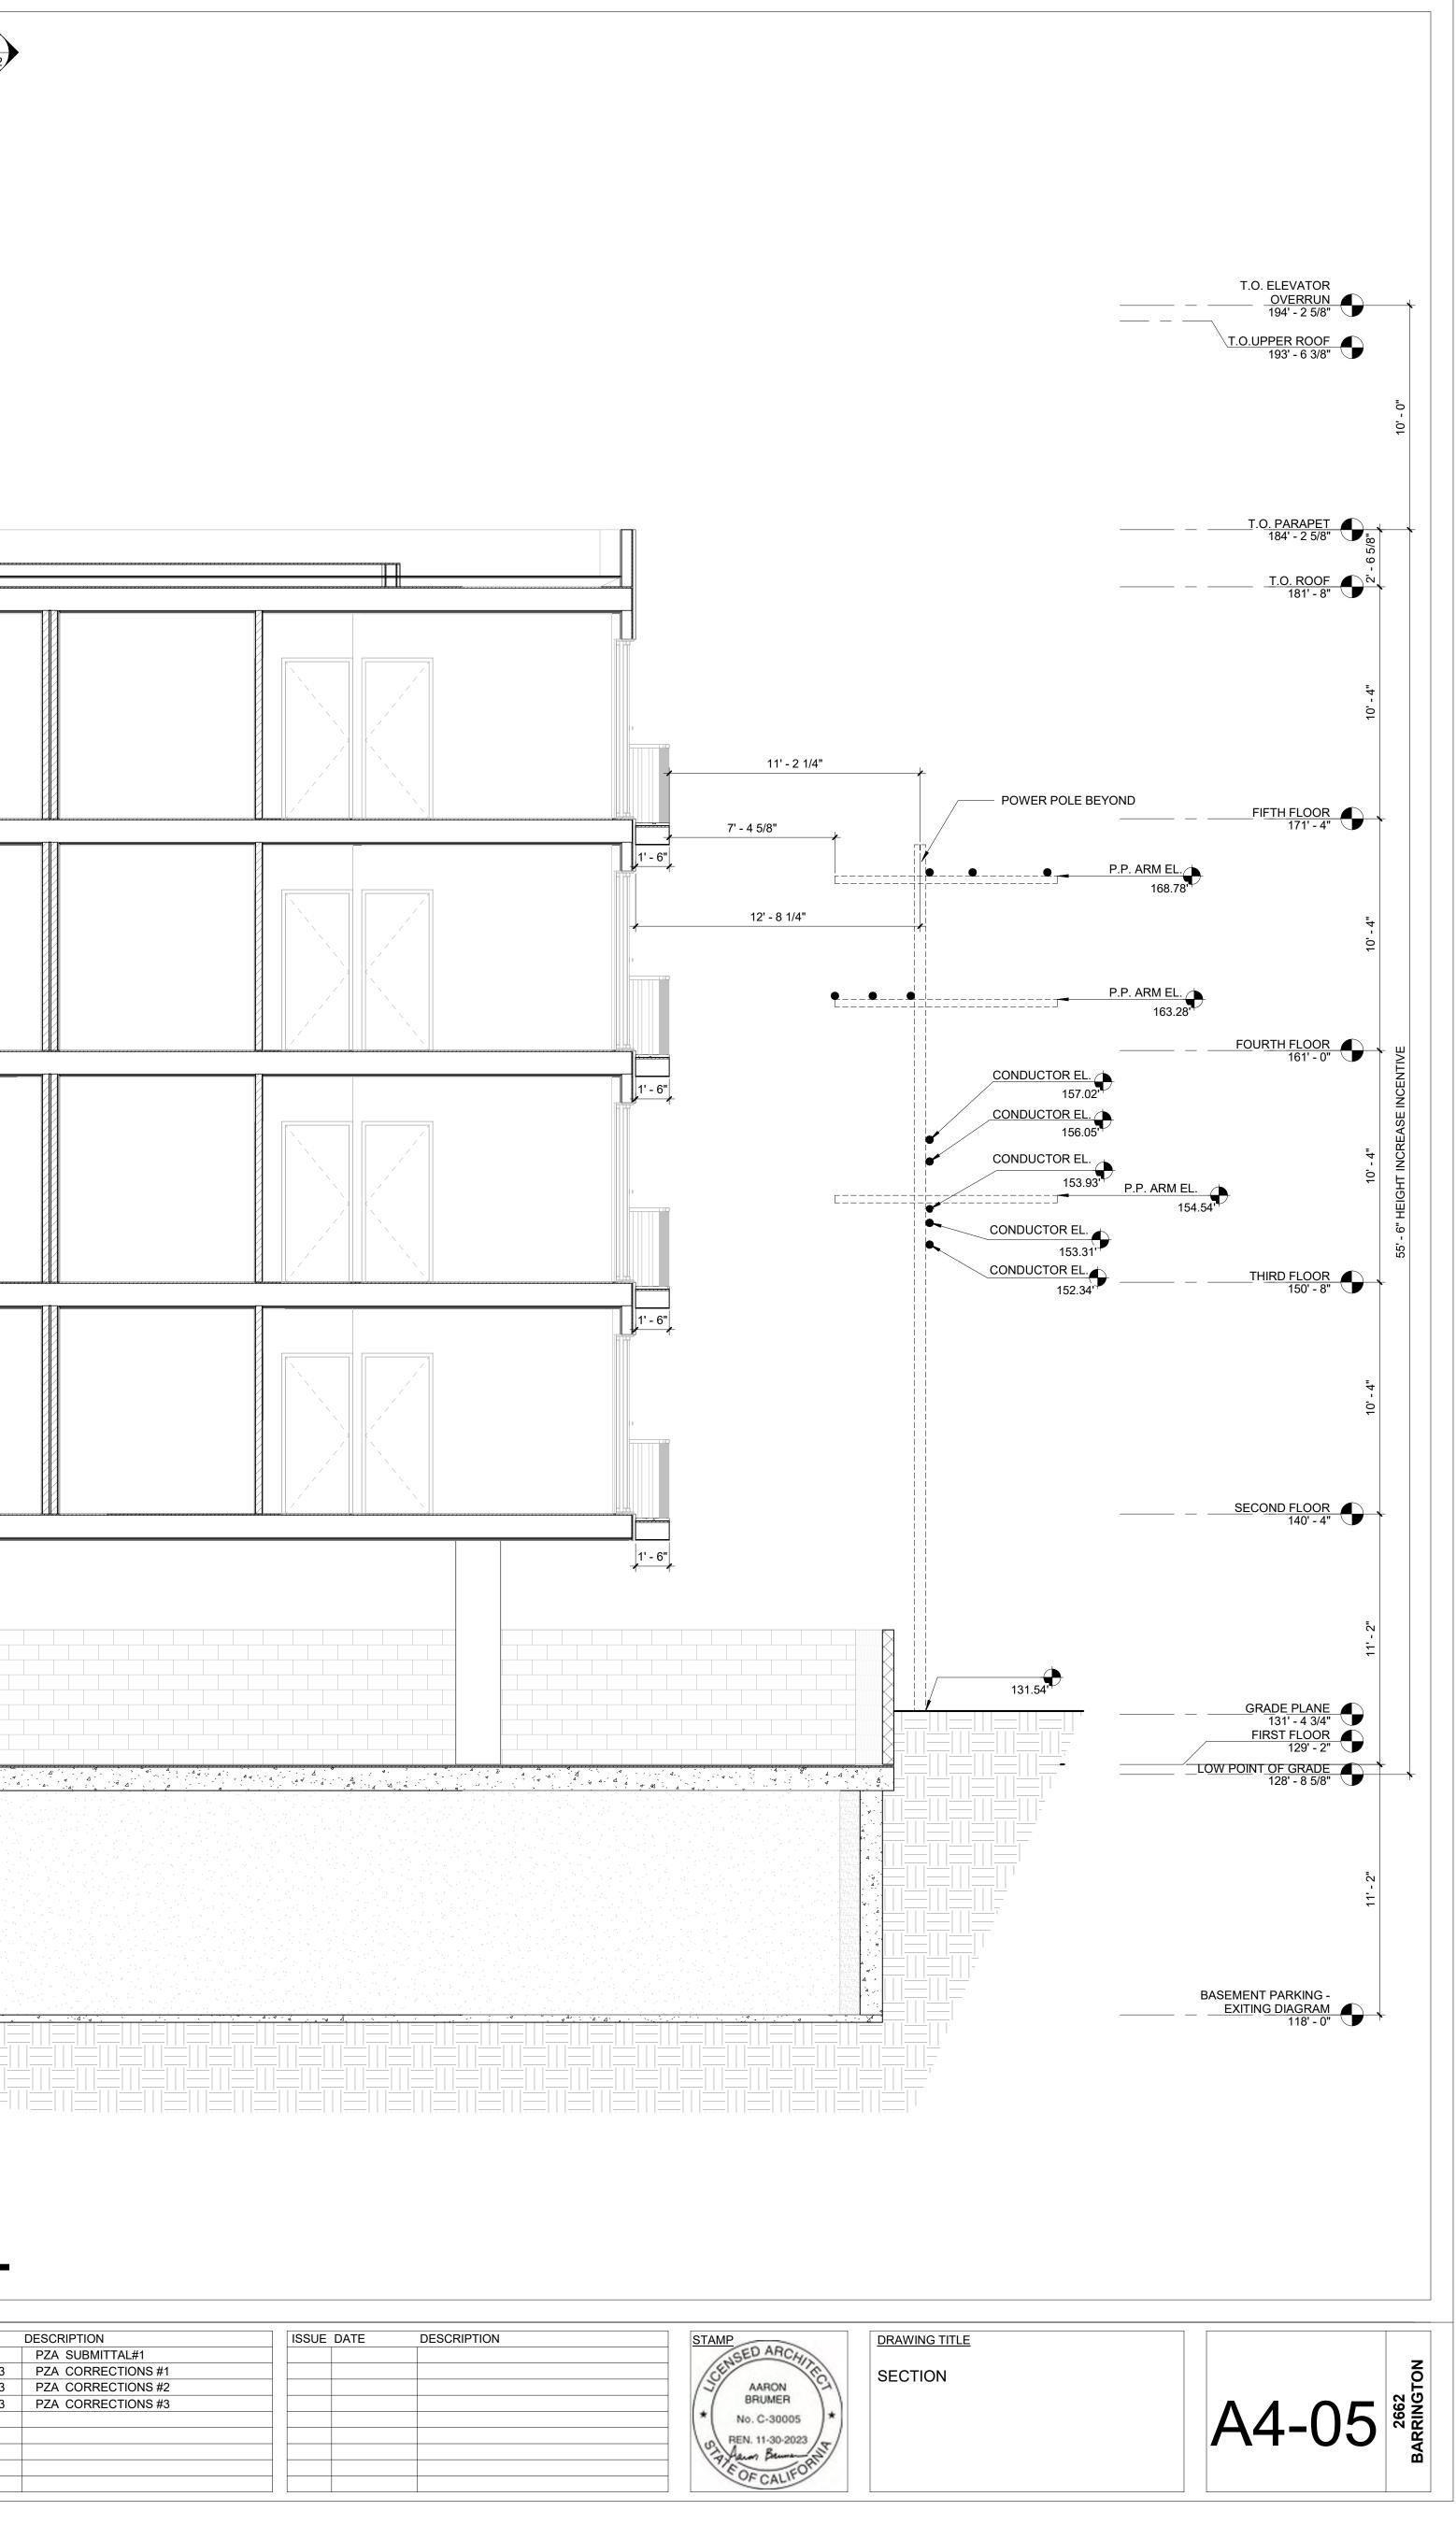
North Hollywood, CA 91602 (310) 422-9234 Email - aaron@aaronbrumer.com

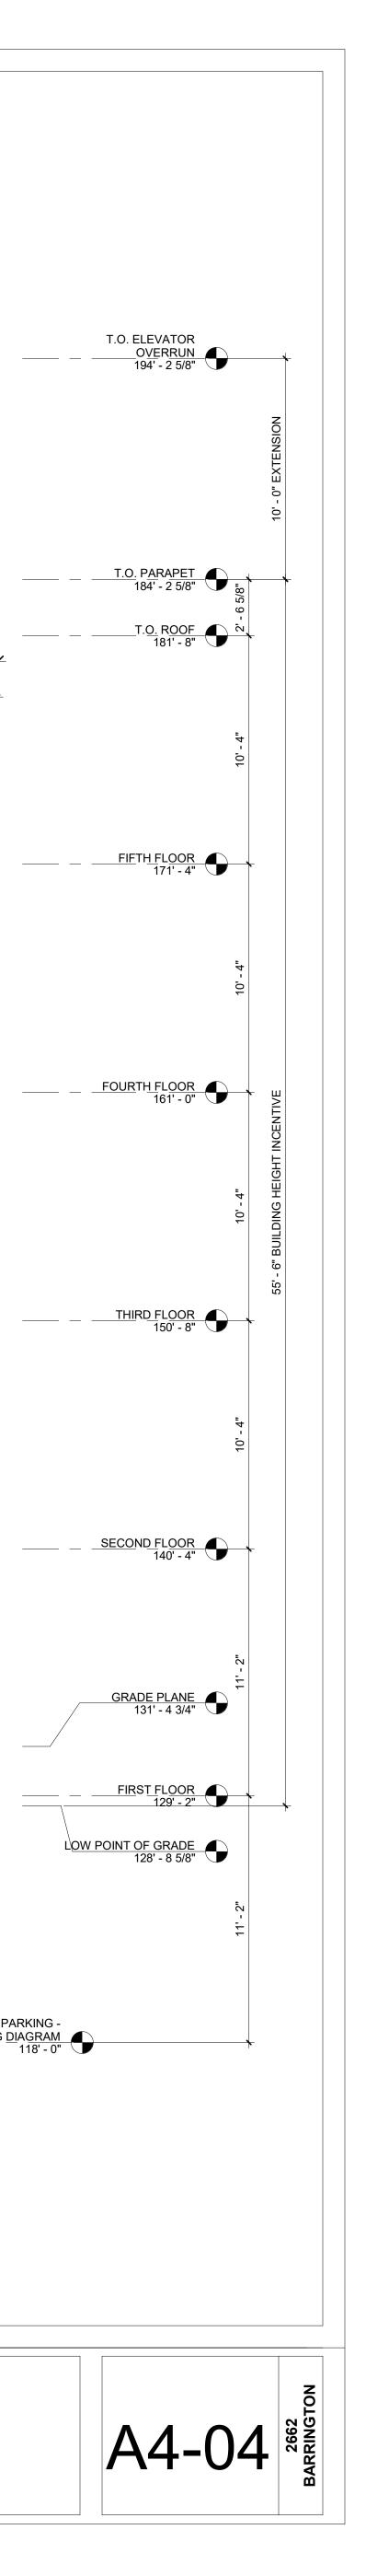(818) 990-6425 Email - aandgstreng@gmail.com

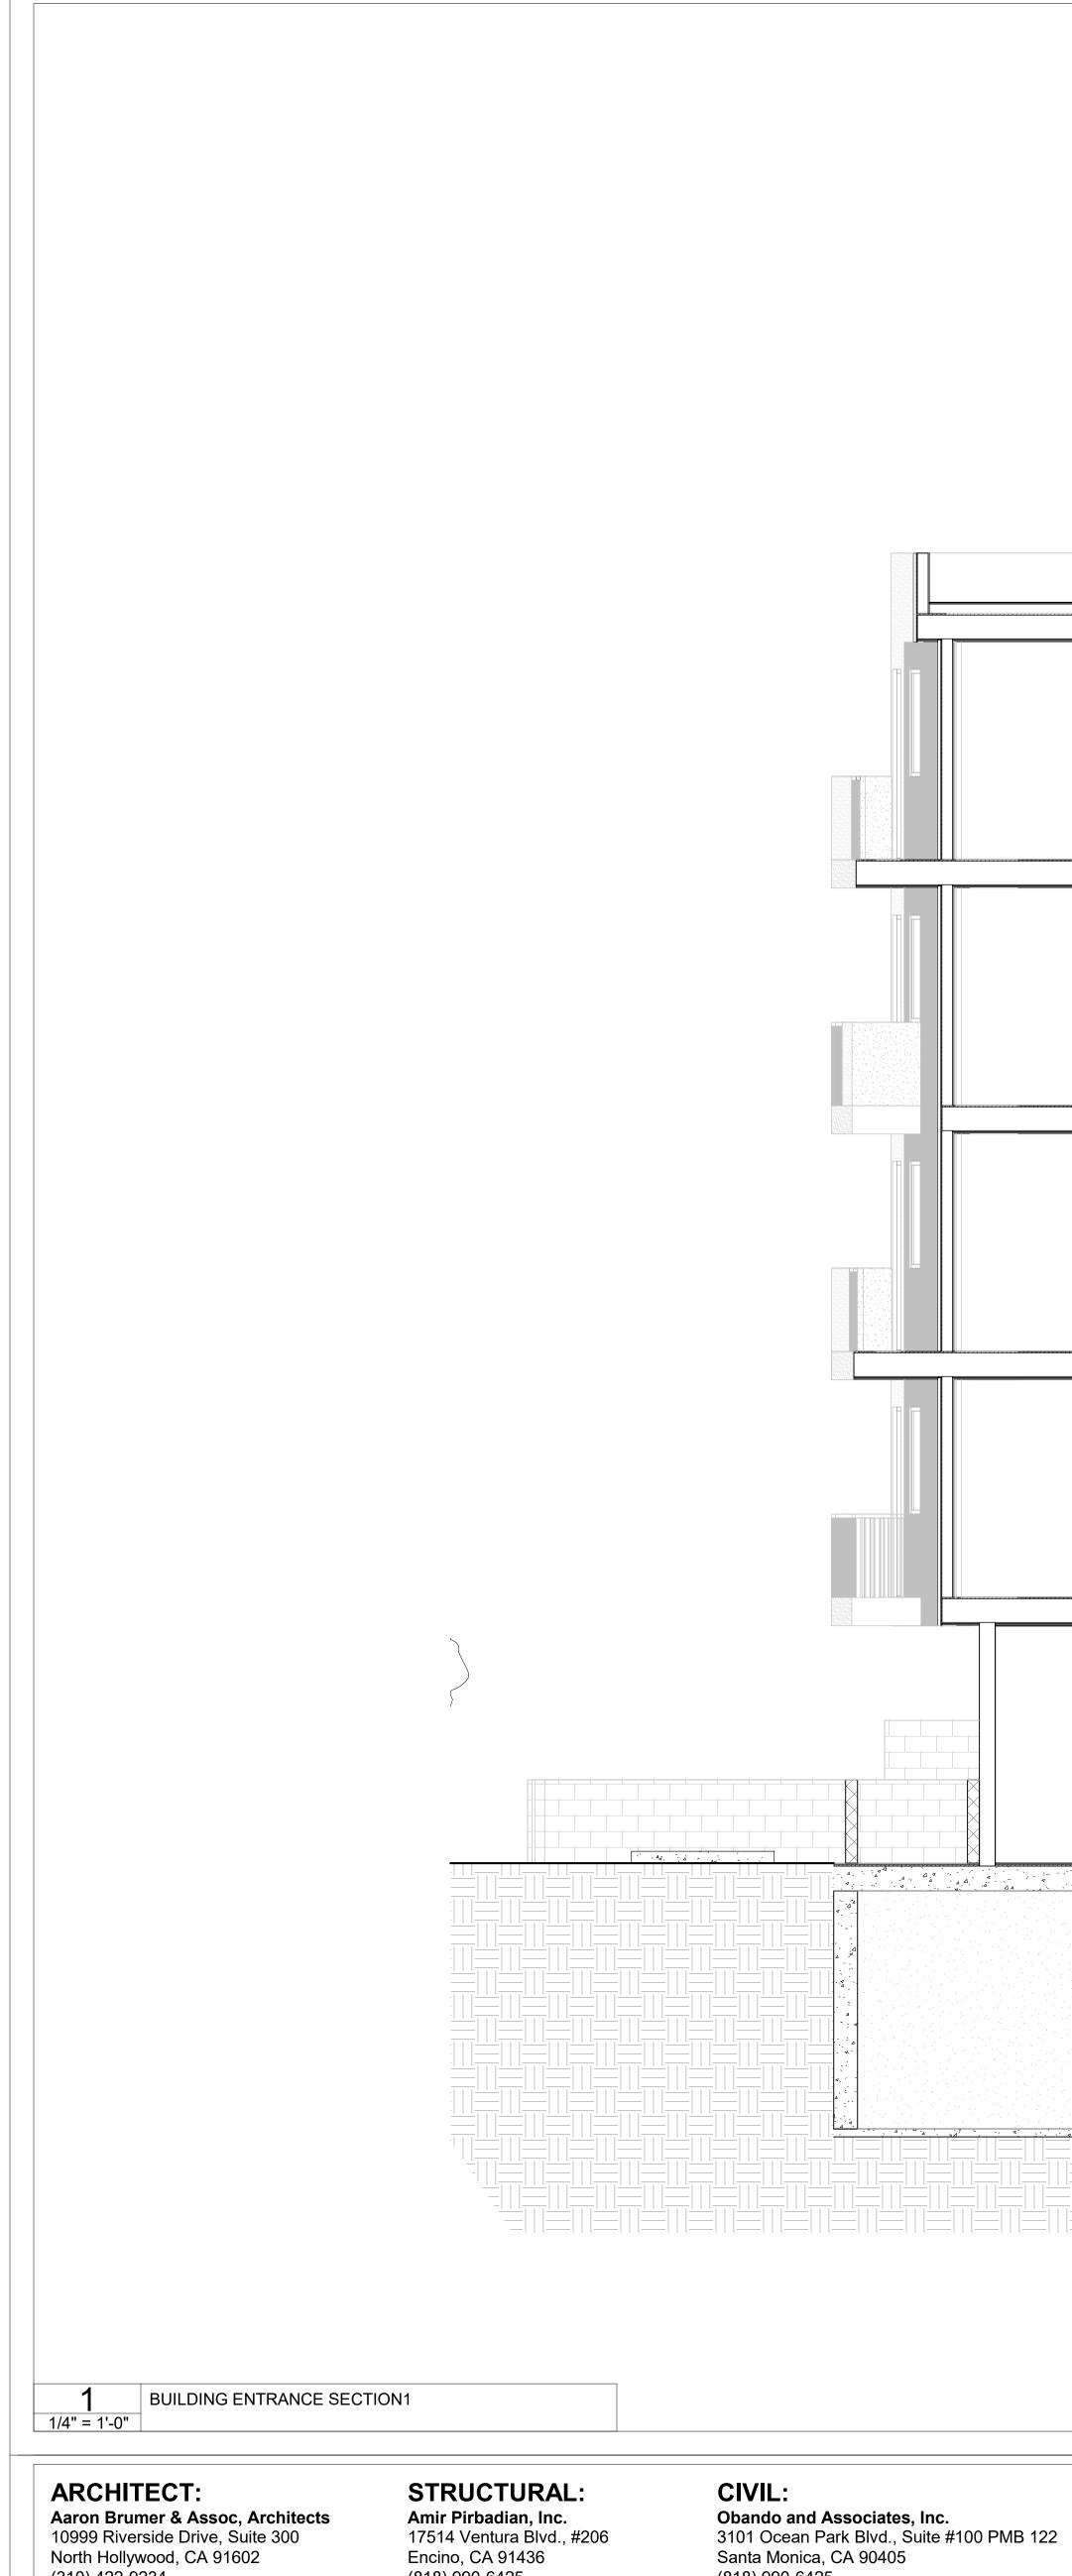Obando and Associates, Inc. 3101 Ocean Park Blvd., Suite #100 PMB 122 Santa Monica, CA 90405 (818) 990-6425 Email - aandgstreng@gmail.com

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		PROJECT: 21-UNIT MULTI FAMIL	Y BUILDING	ISSUE 1 2 3 4	DATE 1/18/2023 03/31/2023 04/17/2023 05/08/2023

2662 BARRINGTON AVE LOS ANGELES, CA 90064



DESCRIPTION	ISSUE DATE	DESCRIPTION	STAMP	DRAWING T
PZA SUBMITTAL#1			SED ARCHIN	
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